

6 X 6 TUBE STEEL POST,

- 1/2" BITUMINOUS FELT

- ASPHALT OR CONCRETE

COMPACTED GRANULAR

BASE COURSE

- CONCRETE FOOTING

TYP.

' ||| ||| ||| ||| ||| ''

(27) COLUMN FOUNDATION DETAIL

1/2" = 1'-0"

CORONADO STONE WALL CAP 12"

PREFINISHED ALUMINUM CAP

5/4 X 8" HARDIE TRIM FIBER

8" CMU BOND BEAM-

2x NAILER BOARD-

<u>SIDING 2</u>

(19) WALL SECTION - SIDING OVER CMU

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FLASHING SET IN MASTIC

(2) #5 CONTINUOUS REINFORCING

CEMENT TRIM BOARD

STRIKE ALL CMU JOINTS WITH

"MODAC" WATERPROOFING

5/4 X 8" PVC TRIM BOARD. TEXTURE

& COLOR TO MATCH HARDIE TRIM

PREFINISHED ALUMINUM "Z"

FIBER CEMENT TRIM

FLASHING

FOUNDATION 1


1" = 1'-0"

SEALANT

WIDE - COLOR "LOMPAC"

3.6' 3.6'

PAVEMENT

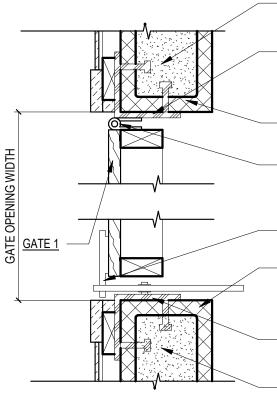

4 ACCESS GATE JAMB DETAIL

3 DOUBLE GATE JAMB DETAIL 1 1/2" = 1'-0"

(2) GATE JAMB DETAIL

1 1/2" = 1'-0"

1 1/2" = 1'-0"

GROUTED CELL ADJACENT TO OPENING W/ #5 VERTICAL REBAR ANGLE IRON ANCHORED TO CONCRETE BLOCK

USE JAMB END BLOCK AT ALL DOOR OPENINGS

CONTINUOUS NON-CORROSIVE HINGE

LATCH OPERABLE FROM BOTH

USE JAMB END BLOCK AT ALL

ANGLE IRON ANCHORED TO

GROUTED CELL ADJACENT TO

CONTINUOUS NON-CORROSIVE HINGE

6-1/2" X 6-1/2" X 1/2" STEEL CAP TRIM

CONTINUOUS NON-CORROSIVE HINGE

GROUTED CELL ADJACENT TO

OPENING W/ #5 VERTICAL REBAR

USE JAMB END BLOCK AT ALL

6-1/2" X 6-1/2" X 1/2" STEEL CAP TRIM

CONTINUOUS NON-CORROSIVE HINGE WELDED TO POST AND BOLTED TO GATE

FRAME - ALLOW FOR 90+ DEGREE SWING

DOOR OPENINGS

6 X 6 STEEL POST

ABOVE, TYP.

GATE 1

WELDED TO POST AND BOLTED TO GATE FRAME - ALLOW FOR 90+ DEGREE SWING

WELDED TO POST AND BOLTED TO GATE

FRAME - ALLOW FOR 90+ DEGREE SWING

OPENING W/ #5 VERTICAL REBAR

SIDES OF GATE

DOOR OPENINGS

CONCRETE BLOCK

GATE 1

6 X 6 STEEL POST


ABOVE, TYP.

GATE 1


WELDED TO POST AND BOLTED TO GATE


FRAME - ALLOW FOR 90+ DEGREE SWING



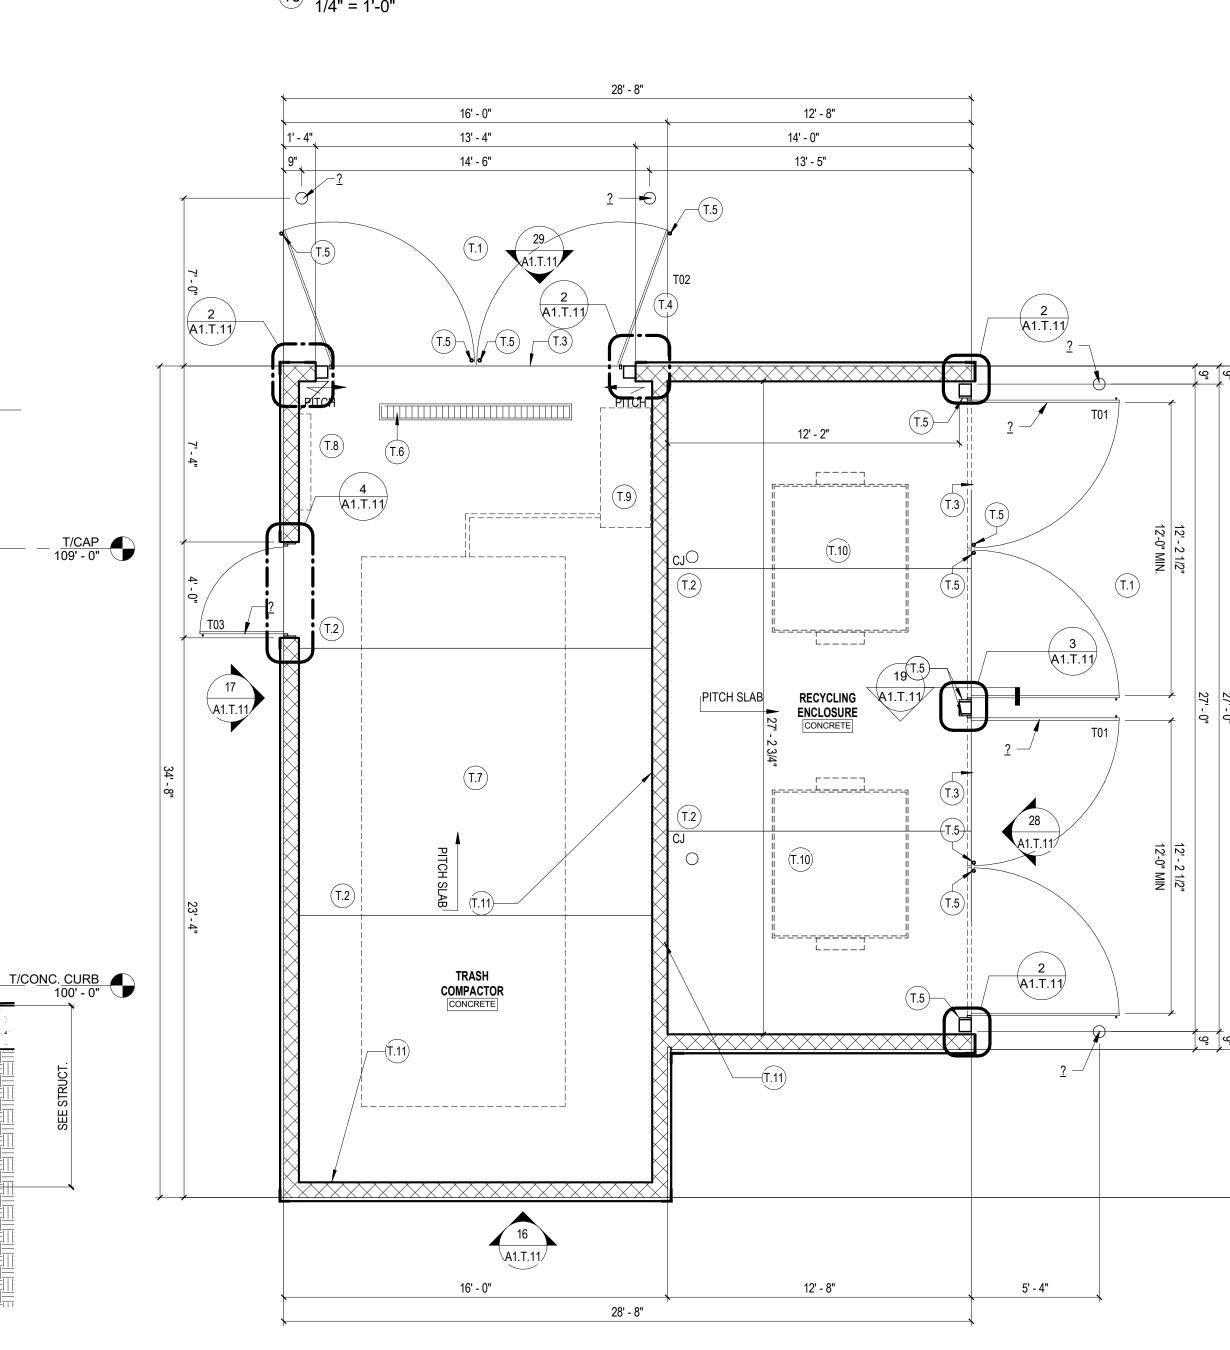

(1	LEFT ELEVATION - TRASH COMPACTOR 1/4" = 1'-0"		
 <u>T/CAP</u> 109' - 0"	2	<u>?</u> <u>?</u> <u>?</u>	2
_T/ <u>CONC. CURB</u>			

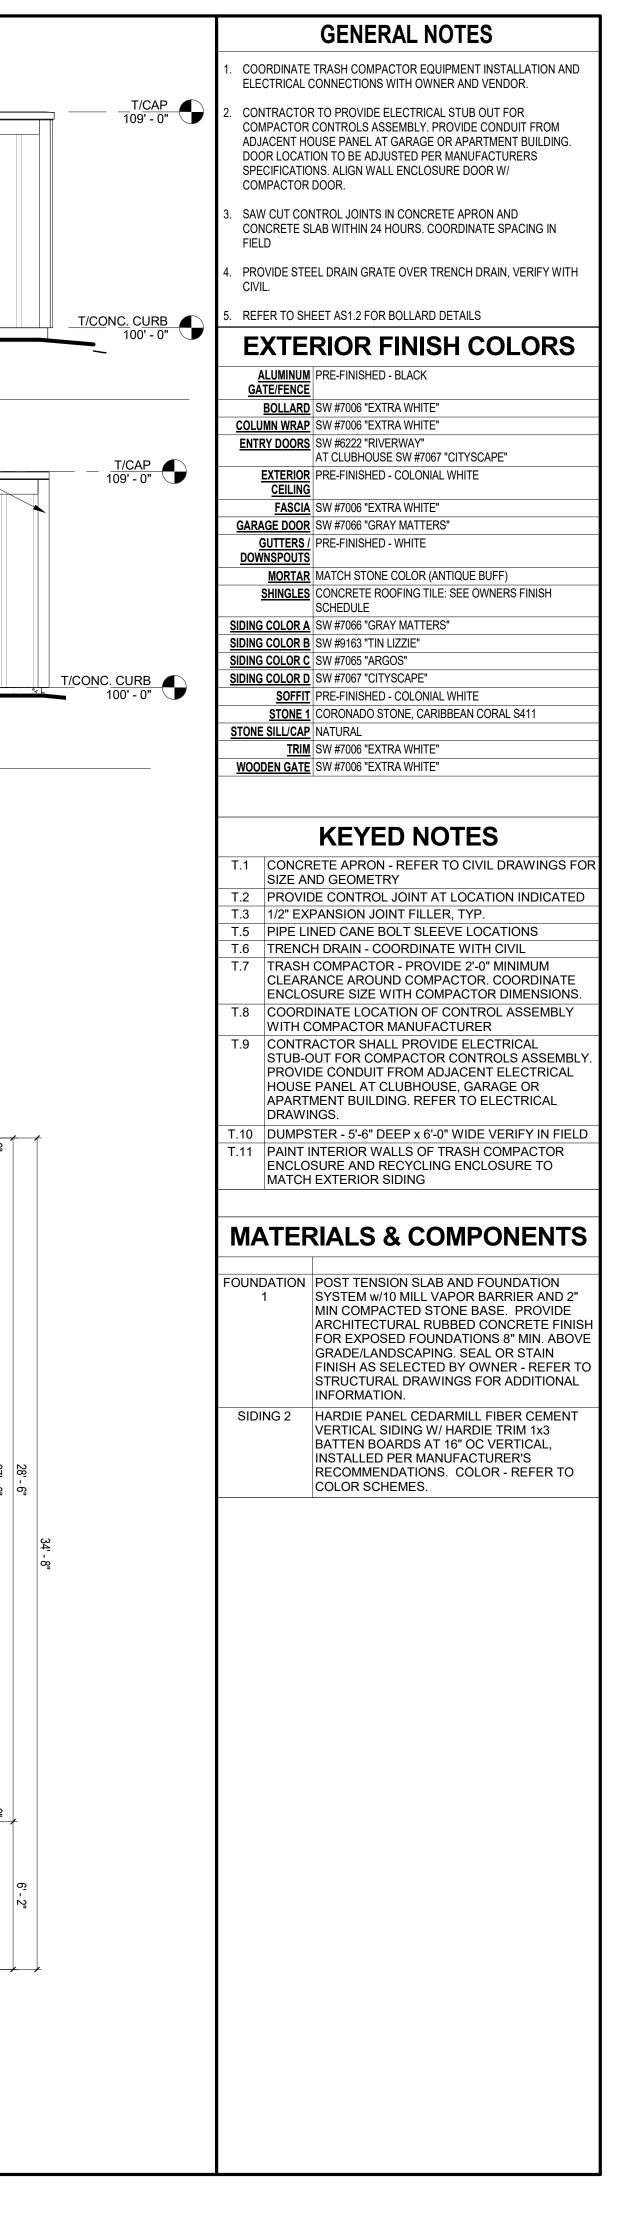


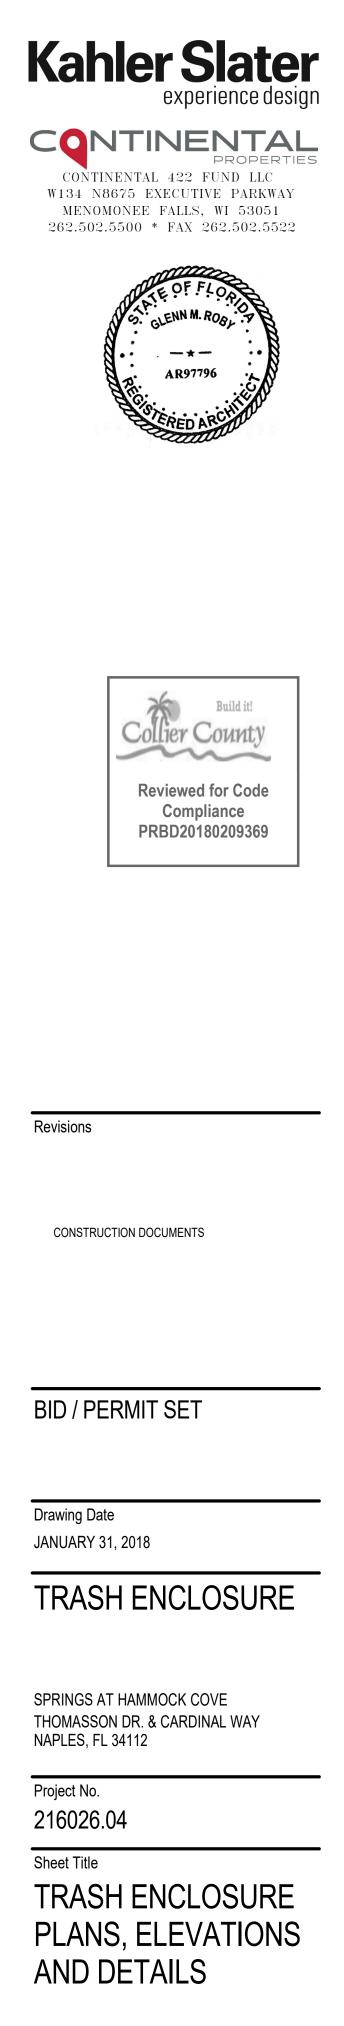



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44 East Mifflin Street, Suite 700, Madison, Wisconsin 53703 Telephone 608.283.6300 Fax 608.283.6317 Sheet No.


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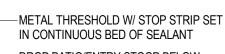




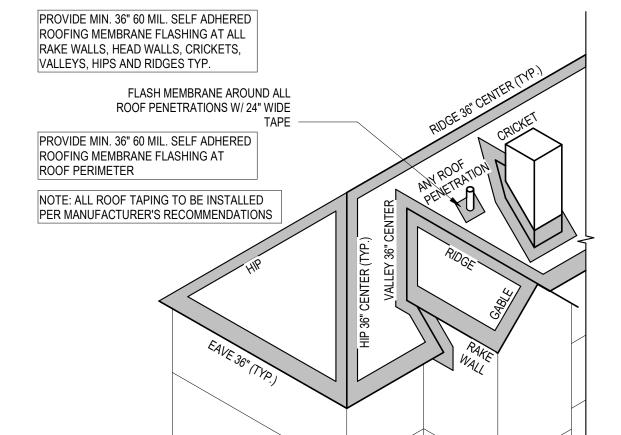


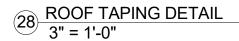

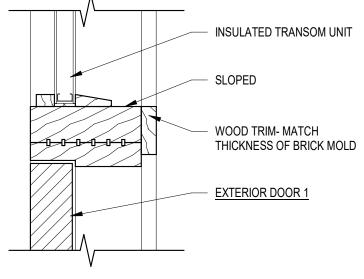

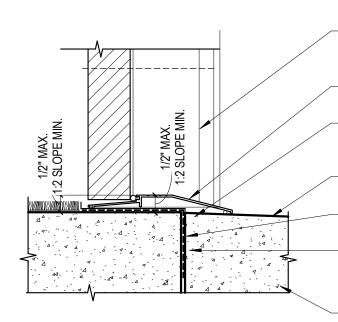



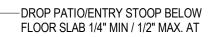

DOOR THRESHOLD

- PROVIDE SKIRT LIKE RAMP UP TO

THRESHOLD WITH 1:48 SLOPE TYPICAL

-METAL PAN FLASHING- EXTEND UP

JAMB 6" MIN.

-SELF-ADHERED FLASHING (UNDER PAN


FLASHING)

— PATIO OR ENTRY SLAB


BEDDING SEALANT @ THRESHOLD/ JAMBS TO TIE-IN TO SEALANT INSTALLED @ BASE OF

SHEATHING


26 <u>TYPICAL DOOR THRESHOLD SILL DETAIL</u> 3" = 1'-0"

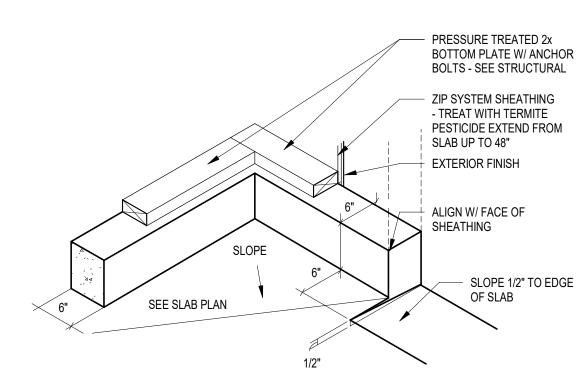


25 CURB AT GARAGE 3" = 1'-0"

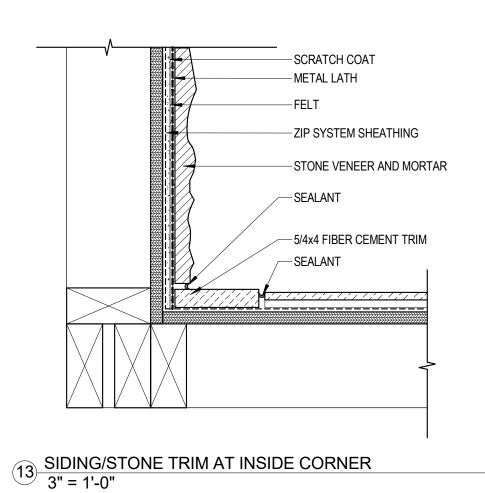





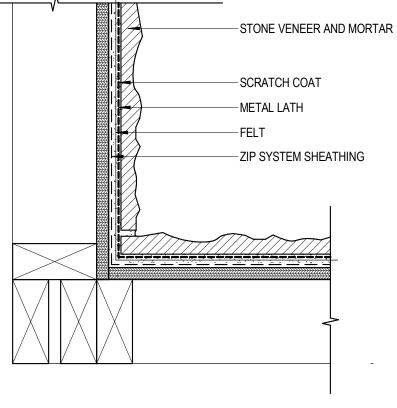


(15) EDGE OF SLAB DETAIL 3" = 1'-0"

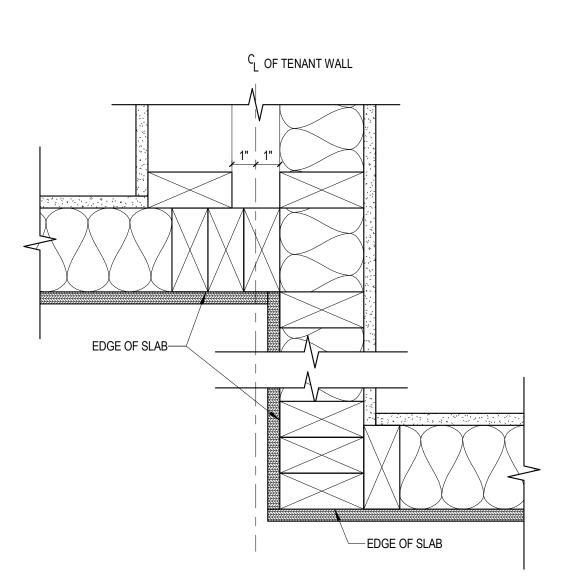

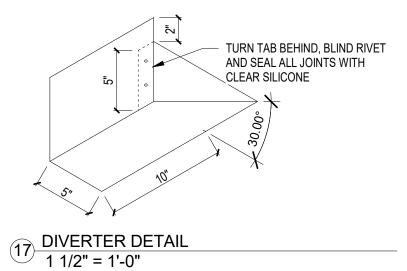


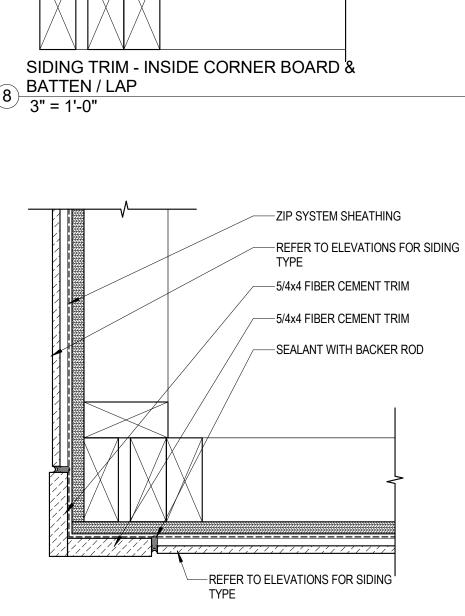


7 SIDING TRIM AT OUTSIDE CORNER 3" = 1'-0"

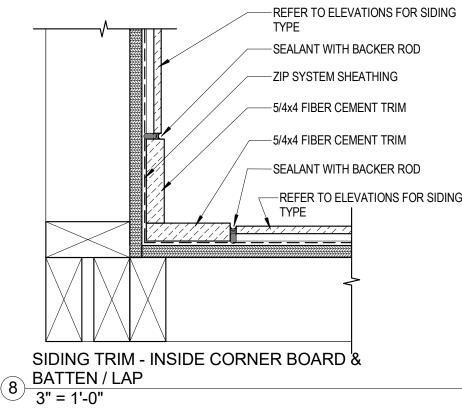




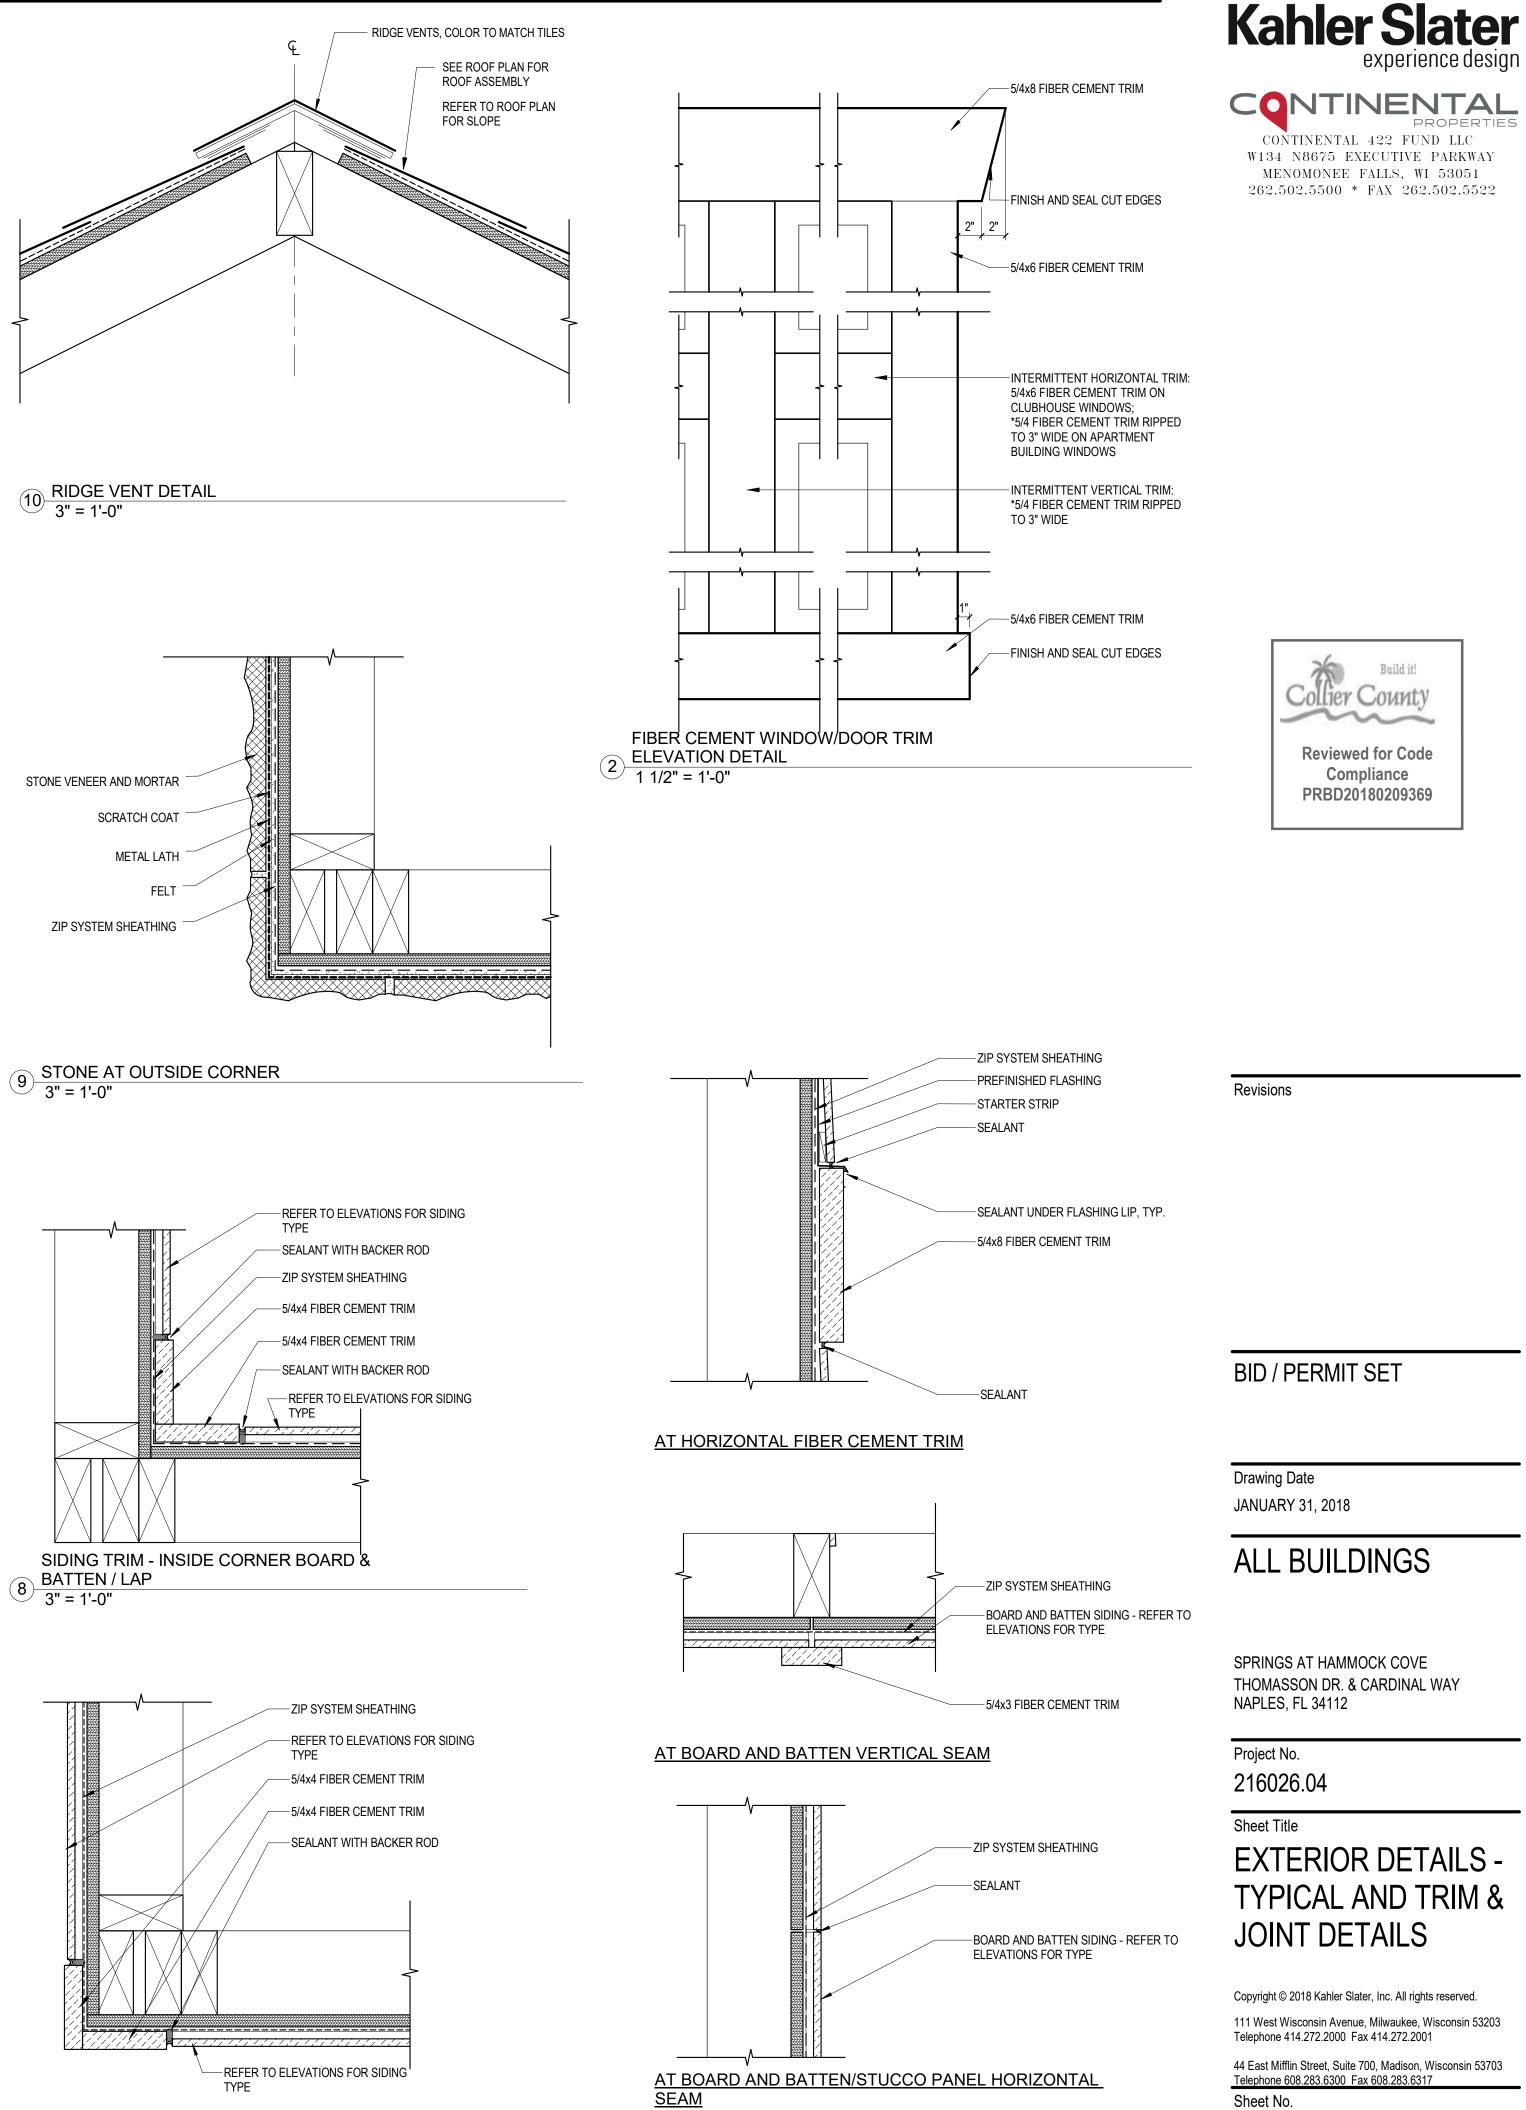

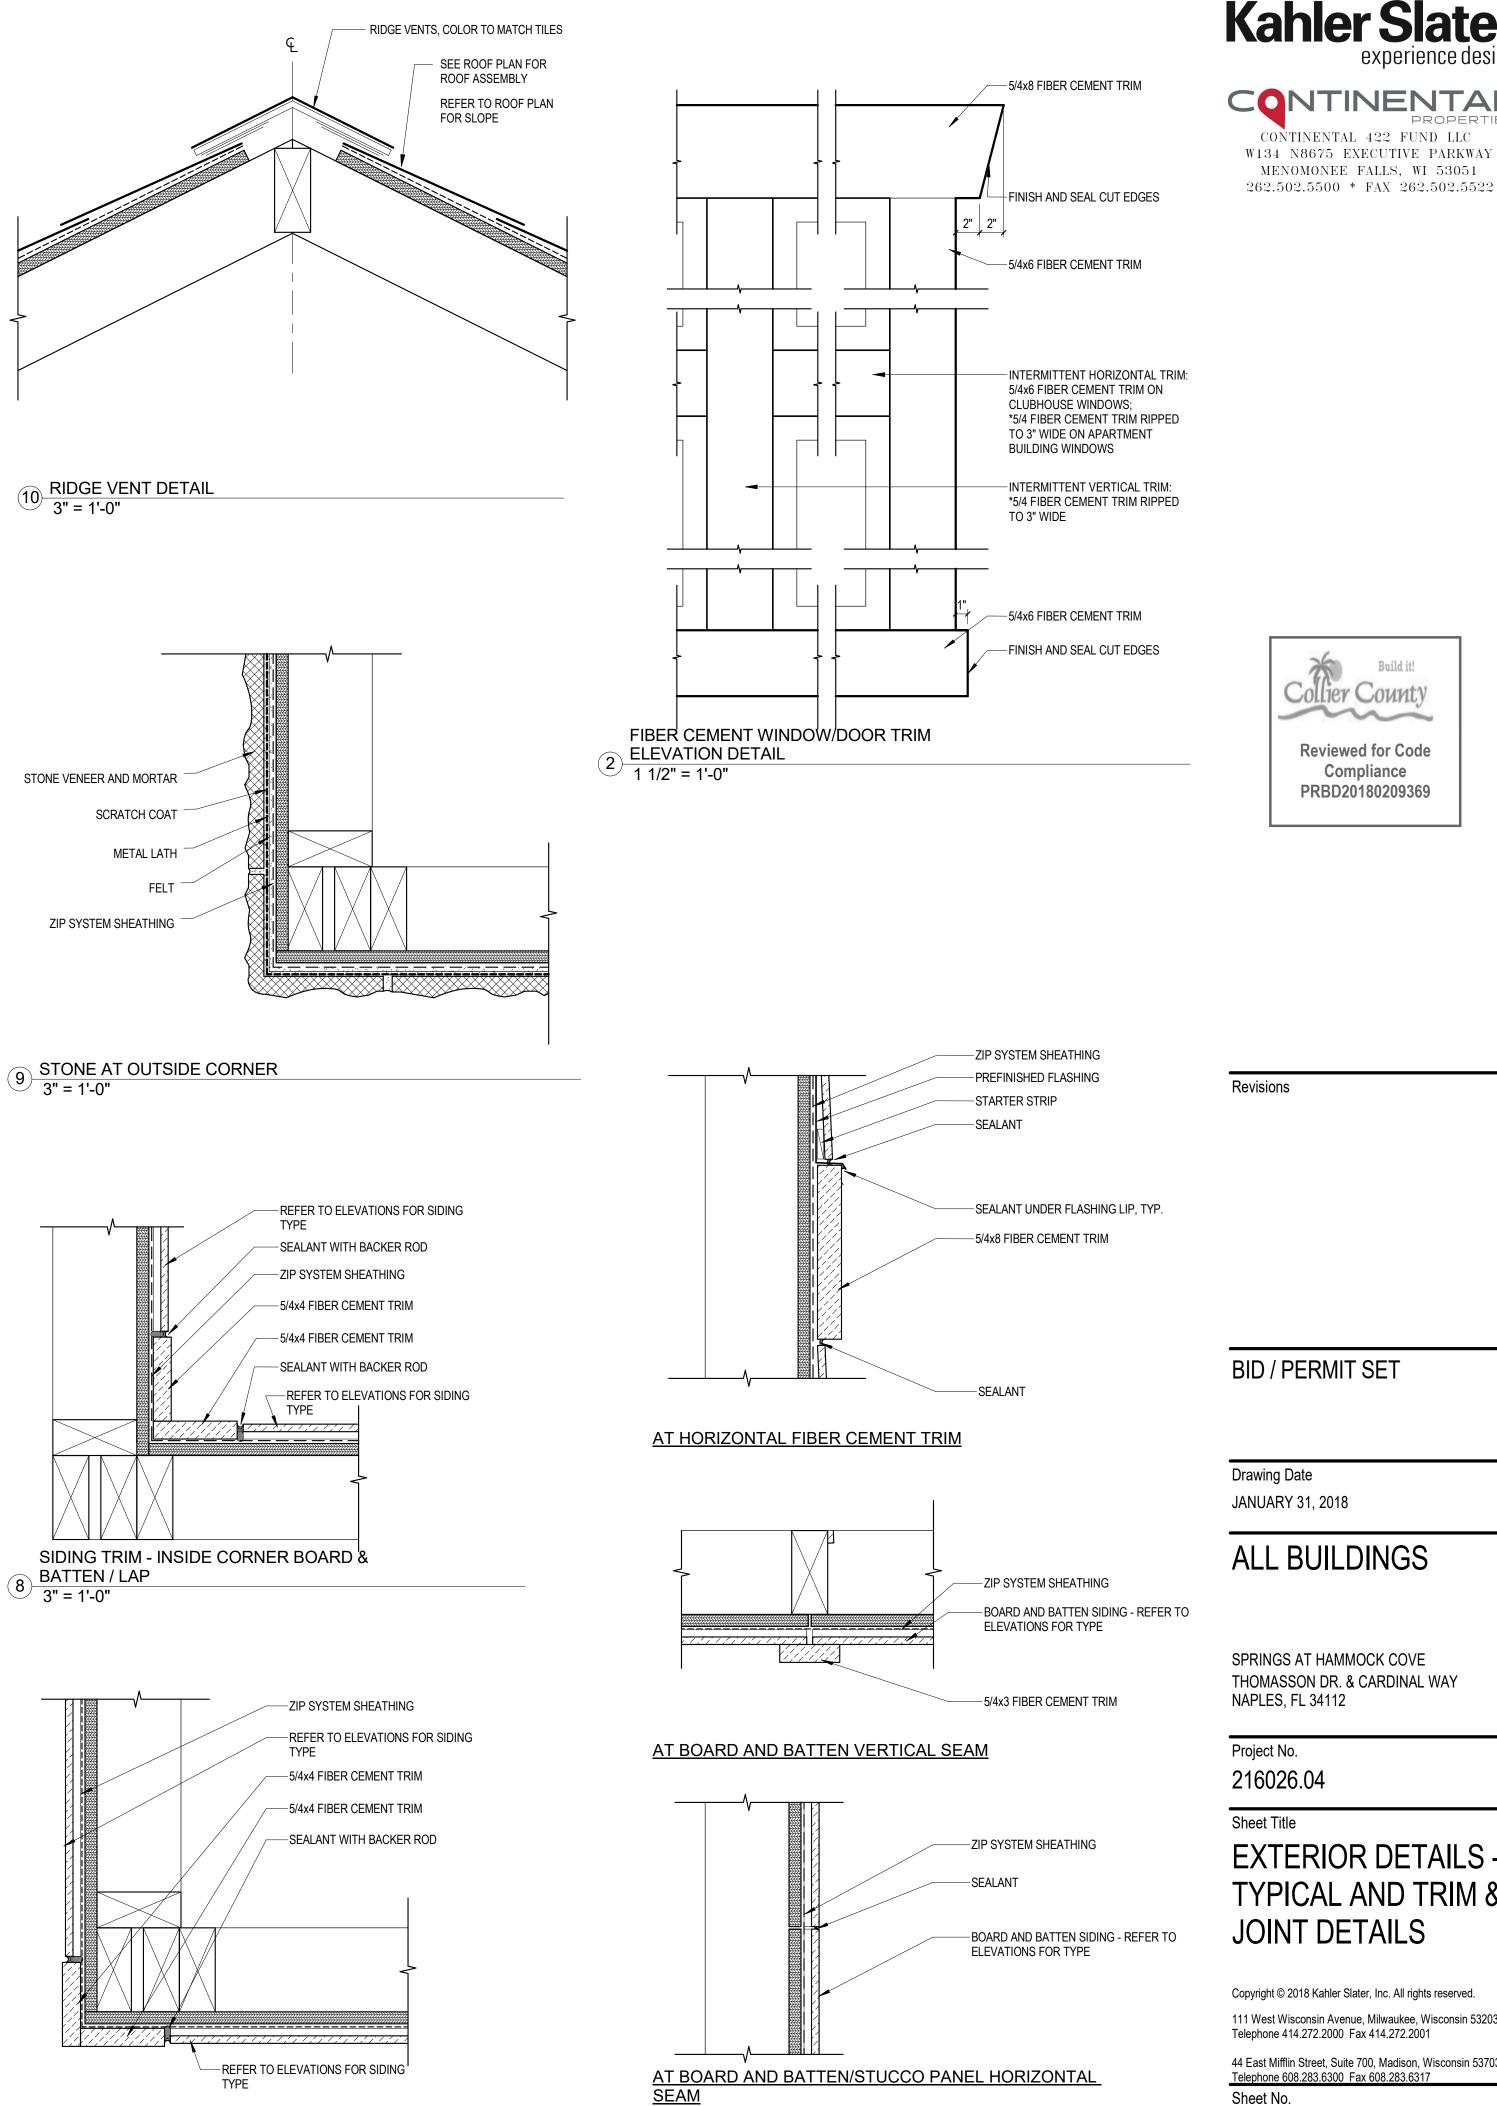

 $1 \frac{\text{TYPICAL FIBER CEMENT JOINT DETAILS}}{3" = 1'-0"}$

A5.01

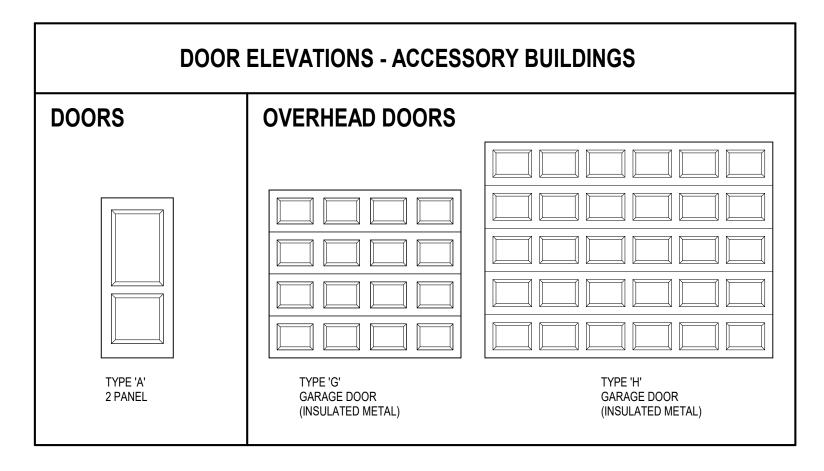

ACCESSORY BUILDING DOOR SCHEDULE

	DOORS			DOOR	DOOR	DETAILS			
DOOR TAG	WIDTH	HEIGHT	TYPE	MATERIAL	HARDWAR E SET	HEAD	JAMB	SILL	REMARKS
G01	8'-0"	7'-0"	G	INSUL. METAL	HW SET 6	SEE S	SHEET A5.	.31	1, 3
M01	3'-0"	7'-0"	А	INSUL. METAL	HW SET 1	SEE S	SHEET A5.	.31	2
M02	3'-0"	7'-0"	А	WOOD	HW SET 2	SEE S	SHEET A5.	.31	
M03	8'-0"	7'-0"	G	INSUL. METAL	HW SET 5	SEE S	SHEET A5.	.31	1
M04	12'-0"	9'-0"	Н	INSUL. METAL		SEE S	SHEET A5.	.31	1
M05	6'-0"	7'-0"	А	INSUL. METAL	HW SET 1	SEE S	SHEET A5.	.31	2
T01	12'-2"	8'-6"	SEE ELEV.	WOOD GATE	HW SET 3	SEE S	SHEET A1.	.T.11	COLOR: PPG #ATC-23 SOLEIL
T02	12'-4"	8'-6"	SEE ELEV.	WOOD GATE	HW SET 3	SEE S	SHEET A1.	.T.11	COLOR: PPG #ATC-23 SOLEIL
T03	4'-0"	8'-6"	SEE ELEV.	WOOD GATE	HW SET 4	SEE S	SHEET A1.	.T.11	COLOR: PPG #ATC-23 SOLEIL

1. PROVIDE WEATHER STRIPPING

 SEALED FRAME AND THRESHOLD AT EXTERIOR DOORS
ALL GARAGE DOOR CONTROLS TO BE MOUNTED 48" A.F.F. MAX. GARAGE DOOR CONTROLS TO BE LOCATED ON LEFT SIDE OF DOOR. COORDINATE WITH OWNER/ARCHITECT.

	(SENERAL HARDWARE NOTES	:					
Α.		NTRACTOR SHALL FIELD VERIFY SIZES OF NEW DOORS AN	ND OR					
B.	INSTALL DOOR, FRAMES AND HARDWARE IN ACCORDANCE WITH MANUFACTURER'S RECOMMENDATIONS AND INSTALLATION INSTRUCTIONS.							
C.	REQUIREMEN	ENERAL CONTRACTOR TO REVIEW AND COORDINATE ALL HARDWARE EQUIREMENTS INCLUDING LOCKING, KEYING, AND OTHER SECURITY EQUIREMENTS WITH OWNER.						
D.	GENERAL CONTRACTOR TO COORDINATE AND INSTALL ALL HARDWARE INCLUDING BUT NOT LIMITED TO LOCKSETS, LATCHSETS, CLOSERS, HINGES, STOPS, ETC. STYLE: AS SELECTED BY OWNER. COLOR/FINISH: BRUSHED NICKEL. INSTALL LEVER TYPE HANDLES AT ALL CLUBHOUSE INTERIOR AND EXTERIOR DOORS; ALL APARTMENT AND STAIR EXTERIOR DOORS, MAINTENANCE BUILDING, AND INSIDE ALL ACCESSIBLE APARTMENT UNITS. INSTALL KNOB TYPE HANDLES IN ALL OTHER APARTMENT UNITS.							
E.		INSTALL FULL PERIMETER WEATHERSTRIPPING AND THRESHOLDS AT ALL EXTERIOR DOORS, ENTRY, PATIO, STAIRS, AND GARAGE.						
F.	CAULK AND S	EAL AROUND FRAMES.						
G.	PROVIDE DOC	OR BELLS AT ADA APARTMENT ENTRY DOORS.						
H.	PROVIDE FIRE	RATED DOOR AND FRAME ASSEMBLIES WHERE REQUIRI	ED BY CODE.					
I.	ALL INTERIOR	DOORS TO BE PREFINISHED, COLOR: WHITE.						
J.	ALL ACCESS (CONTROL DOORS SHALL COMPLY WITH IFC 1008.1.9.8						
	HARDW	ARE SETS: ACCESSORY BUIL	DINGS					
	/ SET 1 (MAINTI	ENANCE BUILDING)						
		OCKSET w/ LEVER HANDLES WEATHERSTRIPPING AND DOOR BOTTOM GASKET SEAL						
ΗW	B. 1.0 PRIVACY	OOM DOOR) (BY PRE-HUNG SUPPLIER) Y LOCKSET w/ LEVER HANDLES TOP OR HINGE PIN STOP						
ΗW	A. 2.0 CONTIN B. 2.0 CARRIA THAN 48" A	HARDWARE- DOUBLE) UOUS NON-CORROSIVE HINGES GE STYLE DECORATIVE HARDWARE (PULLS MOUNTED NC 30VE SLAB) ANE BOLT(S) (TOP OF OPERATION SHALL BE 48" MAX.) IN F TE						
ΗW	A. 1.0 CONTIN B. 1.0 CARRIA THAN 48" A	HARDWARE - SINGLE) UOUS NON-CORROSIVE HINGES OR HEVAY DUTY STYLE H GE STYLE DECORATIVE HARDWARE (PULLS MOUNTED NC BOVE SLAB) ANE BOLT(S) (TOP OF OPERATION SHALL BE 48" MAX.) IN F ITE	HIGHER					
	A. LIFTMASTE B. 882LM CON C. THREE (3) F D. WEATHERF E. SEE OVERF F. BATTERY B.	REMOTES PROOF EXTERIOR KEYPAD IEAD DOOR ASSEMBLIES BELOW ACKUP POWER	DBY POWER					
ΗW	A. GARAGE I EQUIVALE B. KEYPAD (I	.IFTMASTER 877LM) INSTALL KEYPAD ON FACE OF LEFT G EYPAD TO BE INSTALLED 48" A.F.F. MAX COORDINATE W	ARAGE JAMB.					
		VERHEAD DOOR ASSEMBLIES	_					
2. • • •	DOOR SPECS 2" THICK 24 G/ FOAM IN-PLAC PERIMETER W ALL HARDWAF ELECTRIC DO TWO (2) REMC EMERGENCY	AUGE MIN. STEEL BOTH SIDES E PLYURETHANE INSULATION FEATHER STRIPPING AND DOOR BOTTOM SEALS RE, TRACK, AND SPRINGS OR OPENER AND CONTROLS						
	EXTE	RIOR FINISH COLORS						
	ALUMINUM GATE/FENCE	PRE-FINISHED - BLACK						
	BOLLARD	SW #7006 "EXTRA WHITE"						
-		SW #7006 "EXTRA WHITE" SW #6222 "RIVERWAY"						
	EXTERIOR CEILING	AT CLUBHOUSE SW #7067 "CITYSCAPE" PRE-FINISHED - COLONIAL WHITE						
	FASCIA	SW #7006 "EXTRA WHITE"						
<u> </u>	GUTTERS /	SW #7066 "GRAY MATTERS" PRE-FINISHED - WHITE						
		MATCH STONE COLOR (ANTIQUE BUFF)						
	<u>Shingles</u>	CONCRETE ROOFING TILE: SEE OWNERS FINISH SCHEDULE						
		SW #7066 "GRAY MATTERS" SW #9163 "TIN LIZZIE"						
S	IDING COLOR C	SW #7065 "ARGOS"						
<u>S</u>		SW #7067 "CITYSCAPE" PRE-FINISHED - COLONIAL WHITE						
C.	STONE 1	CORONADO STONE, CARIBBEAN CORAL S411						
		SW #7006 "EXTRA WHITE"						
1	WOODEN GATE	SW #7006 "EXTRA WHITE"						



CONTINENTAL 422 FUND LLC W134 N8675 EXECUTIVE PARKWAY MENOMONEE FALLS, WI 53051 262.502.5500 * FAX 262.502.5522



Revisions

BID / PERMIT SET

Drawing Date JANUARY 31, 2018

ACCESSORY BUILDINGS

SPRINGS AT HAMMOCK COVE THOMASSON DR. & CARDINAL WAY NAPLES, FL 34112

Project No. 216026.04

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