			SYMBOLS
			COLD WATER
			HOT WATER SUPPLY
			HOT WATER RETURN
			WASTE OR SANITARY
} —			WASTE OR SANITARY BELOW GRADE
ξ —	— 2"V—		VENT AND SIZE
ξ —	— s —		STORM PIPE BELOW GRADE
}	s _		STORM PIPE ABOVE GRADE
	CD		CONDENSATE DRAIN
}			BALANCING VALVE
			CHECK VALVE VALVE
		+ HB/WH	HOSE BIBB/WALL HYDRANT
}	€		PRESSURE REDUCING VALVE
}	<u></u>		SHUT OFF VALVE
}	-		DIRECTION OF FLOW
	>		REDUCER OR INCREASER
			TOP CONNECTION, 45 OR 90 DEGREES
	— <u> </u>		BOTTOM CONNECTION, 45 OR 90 DEGREES
	Υ		SIDE CONNECTION
			CAPPED OUTLET
-		\longrightarrow	DROP IN PIPING
			RISE IN PIPING
			UNION
	<u> </u>		SOLENOID VALVE
			WATER FLOW MEASURING DEVICE
	9		PRESSURE GAUGE
			VALVE IN RISER

A/E	ARCHITECT/ENGINEER
ACW	AUTOMATIC CLOTHES WASHER
ADA	AMERICANS WITH DISABILITIES ACT
ASME	AMERICAN SOCIETY OF MECHANICAL ENGINEERS
ASTM	AMERICAN SOCIETY FOR TESTING AND MATERIAL
BFF	BELOW FINISHED FLOOR
BHP	BRAKE HORSEPOWER
BTU	BRITISH THERMAL UNIT
C/I	CONTRACTORS INSTALLED
CD	CONDENSATE
CO	CLEANOUT
CONN	CONNECTION
CONT	CONTINUOUS
CV	CHECK VALVE
CW	COLD WATER
DIA	DIAMETER
DN	DOWN
DOMW	DOMESTIC WATER
DWG	DRAWING
ECO	EXTERIOR CLEAN OUT
F	DEGREES FAHRENHEIT
FCO	FLOOR CLEAN OUT
FD	FLOOR DRAIN
FBC	FLORIDA BUILDING CODE
FCW	FILTERED COLD WATER
GAL	GALLONS
GPM	GALLONS PER MINUTE
НВ	HOSE BIBB
HR	HOUR
HW	HOT WATER
I.E.	INVERT ELEVATION
IR	INDIRECT RECEPTOR
MAX	MAXIMUM
MIN	MINIMUM
NFPA	NATIONAL FIRE PROTECTION ASSOCIATION
_	NOT TO SCALE
NTS	
O/F	OWNER FURNISHED
PD	PUMP FURNISHED
PDI	PLUMBING DRAINAGE INSTITUTE
PRL	PRESSURE RELIEF LINE
PSIG	POUNDS PER SQUARE INCH
RWL	RAIN WATER LEADER
RM	ROOM
SPC	STANDARD PLUMBING CODE
ST	STORM
STO	STORM OVERFLOW
T&P	TEMPERATURE & PRESSURE
TPV	TRAP PRIMER VALVE
TYP	TYPICAL
U/G	UNDERGROUND
W/	WITH

GENERAL NOTES

- A. CONTRACTOR SHALL BE RESPONSIBLE TO PERFORM ALL WORK IN STRICT ACCORDANCE WITH THE 2014 FLORIDA BUILDING CODE, WITH ALL APPLICABLE LOCAL CODES AND ORDINANCES.
- CONTRACTOR SHALL VERIFY AND CORRECT AS REQUIRED TO MEET ALL CODES AND REGULATIONS ANY POSSIBLE DISCREPANCIES BETWEEN TYPE AND SIZE OF CONNECTION SPECIFIED IN PLUMBING FIXTURE SCHEDULE AND FIXTURES ACTUALLY INSTALLED ON THE SITE.
- C. VALVES AND FITTINGS SHALL BE OF SAME SIZE OF LINE ON WHICH THEY ARE LOCATED.
- D. CONTRACTOR SHALL COORDINATE ALL WORK WITH OTHER TRADES.
- CONTRACTOR SHALL FIELD VERIFY ALL GIVEN MEASUREMENTS PRIOR TO E. LAYING AND CONNECTING ALL PIPING SYSTEMS AND NOTIFY ARCHITECT OF ANY DISCREPANCIES.
- F. CONTRACTOR SHALL BE RESPONSIBLE FOR MAINTAINING FIRE RATING AND WEATHERPROOFING INTEGRITY OF ALL PIPING AND PENETRATIONS.
- G. ALL WATER SUPPLY AND SANITARY LINES SHALL BE RUN AS CLOSE TO PLANS AS POSSIBLE WITH NO CHANGES IN SIZING.
- H. CONTRACTOR SHALL BE RESPONSIBLE FOR PROVIDING ALL NECESSARY SUPPORTING DEVICES FOR ALL FIXTURES INCLUDED IN CONTRACT OR HEREIN SPECIFIED OR OTHERWISE.
- ROUTE ALL PIPING CONCEALED ABOVE CEILINGS, WITHIN WALLS, OR IN CHASES, PIPING EXPOSED SHALL BE SLOPED AND PAINTED TO MATCH ARCHITECTURAL FINISHES. PIPING IN MECHANICAL ROOMS MAY BE EXPOSED.
- SEE ARCHITECTURAL DRAWINGS FOR EXACT LOCATIONS OF PLUMBING FIXTURE MOUNTING HEIGHTS, AND DIMENSIONS.
- K. CONTRACTOR SHALL INSTALL DIELECTRIC UNIONS AT CONNECTIONS OF DISSIMILAR METALS.
- CONTRACTOR SHALL ROUGH-IN, ALL WASTES AND SUPPLIES TO SPECIAL EQUIPMENT ACCORDING TO MANUFACTURER'S SHOP DRAWINGS AND MAKE FINAL CONNECTIONS. ALL SUPPLIES SHALL BE VALVED, INSTALL VACUUM BREAKERS WHERE REQUIRED BY CODE.
- M. ALL WATER PIPING INSTALLED IN EXTERIOR WALLS SHALL BE PLACED ON THE INTERIOR SIDE OF THE WALL, SO THAT WALL INSULATION CAN BE PLACED ON THE EXTERIOR SIDE OF THE PIPING.
- N. DO NO PENETRATE WALL FOOTINGS WITH PIPING, COORDINATE WITH GENERAL CONTRACTOR TO DROP FOOTINGS AS REQUIRED TO CLEAR PLUMBING SERVICES WHERE ABSOLUTELY NECESSARY. ALL PIPING PENETRATING A BEARING WALL OR FOOTING MUST BE SLEEVED AND LOCATION APPROVED BY STRUCTURAL ENGINEER.
- O. PIPING SHALL ESSENTIALLY BE ROUTED AND LOCATED AS INDICATED ON THE DRAWINGS: HOWEVER, ACTUAL PLACEMENT SHALL BE VERIFIED BY CONFIRMING EXACT LOCATION OF STRUCTURES AND OTHER UTILITIES IN THE FIELD AND BY CAREFUL LAYOUT PRIOR TO EXECUTION OF THE WORK. DRAWINGS ARE GENERALLY DIAGRAMMATIC. PIPING SHALL BE CONCEALED EXCEPT WHERE SPECIFICALLY NOTED OTHERWISE.
- P. VALVES ABOVE HARD CEILINGS SHALL BE PROVIDED WITH CEILING ACCESS HATCHES PER ARCHITECTURAL SPECIFICTIONS.
- Q. VALVES ABOVE HARD CEILINGS SHALL BE PROVIDED WITH CEILING ACCESS HATCHES PER ARCHITECTURAL SPECIFICTIONS.
- R. IN ADDITION TO PROVIDE VALVE TAGS, CONTRACTOR SHALL AFFIX A LABEL TO CEILING GRID OR ACCESS DOOR INDICTING VALVE FUNCTION AND
- CONTRACTOR SHALL COORDINATE EXACT PLUMBING FIXTURE LOCATION WITH ARCHITECTURAL DIMENSIONED ARCHITECTURAL PLANS PRIOR TO ROUGHING IN. THE PLUMBING DRAWINGS ARE DIAGRAMMATIC AND DO NOT REPRESENT EXACT LOCATIONS.
- PROVIDE WALL CLEANOUT AT THE BASE OF EACH SANITARY AND STORM VERTICAL STACK AS REQUIRED PER FLORIDA PLUMBING CODE. PROVIDE CLEANOUT ACCESS COVERS.
- U. THE PLANS HAVE BEEN PREPARED BASED ON A RECENT SURVEY AND CONSTRUCTION DOCUMENTS FROM PREVIOUS PROJECTS AND ARE THE BEST SOURCES OF INFORMATION TO DATE. ALL PIPING, EQUIPMENT, UTILITIES, ETC. SHALL BE FIELD VERIFIED. PLANS SHALL NOT BE SCALED.

PLUMBING FIXTURE SCHEDULE

MARCO ISLAND EXECUTIVE AIRPORT

DATE: MAY 2017

NOTES: . COORDINATE COLOR OPTIONS W/ INT. DESIGN SHEETS PRIOR TO ORDERING. PRICE AS STANDARD COLOR OPTIONS. 2. SEE ARCHITECTURE SHEETS FOR MOUNTING HEIGHTS.

FIXTURE TAG	DESCRIPTION & ACCESSORIES	MANUFACTURER	MODEL NUMBER	WASTE	VENT	CW	HW
WC-1	ELONGATED VITREOUS CHINA, WALL MOUNTED, 1-PIECE (14" HIGH) SIPHON JET SENSOR ACTIVATE FLUSH VALVE, 12V AC TRANSFORMER FOR MULTIPLE VALVES, DIAPHRAGM TYPE 1.28 GPF, WITH OPEN TOILET SEAT & HARDWARE PROVIDE MOUNTING RING, BOLTS, STOP. PROVIDE ZURN NARROW WALL CARRIER SYSTEM ZN1201-ND4 OR ZN1209-N4 OR APPROVED EQUAL.	KOHLER MOEN	K-4325 8311AC12	4"	2"	1"	
WC-2 (ADA)	ELONGATED VITREOUS CHINA, WALL MOUNTED, 1-PIECE (17" HIGH) SIPHON JET SENSOR ACTIVATED FLUSH VALVE, 12V AC TRANSFORMER FOR MULTIPLE VALVES, DIAPHRAGM TYPE 1.28 GPF, WITH OPEN TOILET SEAT & HARDWARE PROVIDE MOUNTING RING, BOLTS, STOP, ADA COMPLIANT. PROVIDE ZURN NARROW WALL CARRIER SYSTEM ZN1201-ND4 OR ZN1209-N4 OR APPROVED EQUAL.	KOHLER MOEN	K-4325 8311AC12	4"	2"	1"	
U-1	VITREOUS CHINA, BARRIER FREE, LOW CONSUMPTION 0.125 GPF, WASHOUT, 3/4" INLET SPUD, SENSOR ACTIVATED FLUSH VALVE, 12V AC TRANSFORMER FOR MULTIPLE VALVES, DIAPHRAGM TYPE	KOHLER MOEN	K-5452-ET 8316AC	2"	2"	3/4"	
U-2 (ADA)	VITREOUS CHINA, BARRIER FREE, LOW CONSUMPTION 0.125 GPF, WASHOUT, 3/4" INLET SPUD, SENSOR ACTIVATED FLUSH VALVE, 12V AC TRANSFORMER FOR MULTIPLE VALVES, DIAPHRAGM TYPE, ADA COMPLIANT	KOHLER MOEN	K-5452-ET 8316AC	2"	2"	3/4"	
L-1	VITREOUS CHINA, COUNTERTOP MOUNT, 0.35 GPM AERATOR, FRONT OVERFLOW, SINGLE HOLE, SENSOR ACTIVATED FAUCET, 12V AC TRANSFORMER, STRAINGER, TRAP, STOPS, CW ONLY	KOHLER KOHLER	K-2196-1 K-13463	2"	1 1/2"	1/2"	
L-2 (ADA)	VITREOUS CHINA, WALL HUNG, CONCEALED ARE CARRIER, SINGLE HOLE, SENSOR ACTIVATED FAUCET, 12V AC TRANSFORMER, STRAINER, TRAP, STOPS, CW ONLY, ADA COMPLIANT	KOHLER KOHLER	K-2007 K-13463	2"	1 1/2"	1/2"	
S-1	DOUBLE BOWL SINK, DROP-IN STAINLEES STEEL, 8" DEEP SINK, STRAINER, TRAP, STOPS, TOP MOUNT FAUCET WITH GOOSENECK SWING SPOUT, LEVER HANDLES, 1.5 GPM, 1.0 HP HEAVY DUTY DISPOSAL, REVERSING MOTOR	ELKAY T&S BRASS INSINKERATOR	LR3322 B-1142-QT5XPF15 EVOLUTION EXCEL	2"	2"	1/2"	1/2"
S-2	SINGLE BOWL SINK, UNDERMOUNT STAINLESS STEEL, 6" DEEP SINK, STRAINER, TRAP, STOPS, DECK MOUNT FAUCET WITH GOOSENECK SWING SPOUT, LEVER HANDLES, 1.5 GPM	ELKAY ELKAY	DXUH1318 LKD208813C	2"	2"	1/2"	1/2"
SH-1 (ADA)	HAND SHOWER W/ 60" HOSE, 24" METAL SLIDE BAR, 1.5 GPM ANTI- SCALD THERMOSTATIC MIXING VALVE, CI BODY, ADJUSTABLE COLLAR W/ 5" SQ NICKLE BRONZE VANDAL RESISTANT STRAINER	SYMMONS ZURN	S-96-300-B30-L-X-1.5 ZN415B-A5	2"	2"	1/2"	1/2"
EWC-1	WALL MOUNTED, STAINLESS STEEL, BI-LEVEL, VANDAL RESISTANT 50F OUTLET. 3/8" STOP, INSULATED COLD LINES CHROME PLATED P-TRAP, CARRIER WITH P-TRAP HANGER PLATE AND BACKING, CARBON FILTER, BOTTLE FILLING STATION	HALSEY TAYLOR	HTHB-HACBLWF	2"	1 1/2"	1/2"	
HB-1	HOSE BIBB, VANDAL RESISTANT, 3/4" MALE HOSE CONNECTION, LOOSE KEY, VACUUM BREAKER	WOODFORD	24			3/4"	
WH-1	WALL HYDRANT, EXPOSED, FREEZE PROOF, ANTI-SIPHON, BRASS CASING, VACUUM BREAKER, ALL BRONZE INTERIOR PARTS AND NON TURNING OPERATING ROD WITH FREE FLOATING COMPRESSION CLOSURE VALVE WITH CHROME FINISH AND OPERATING KEY, PROVIDE ROUND BOX ON TILT WALL CONSTRUCTION.	WATTS	HY-725-R			3/4"	
IB-1	ICE MAKER OUTLET BOX, NO-LEAD VALVES, W/ ARRESTOR	SIOUX CHEIF	696-G1010			1/2"	
MS-1	FLOOR MOUNTED 24X24X12 MOP SINK WITH STAINLESS STEEL CURB CAP, PROVIDE TRAP, STRAINER PROVIDE SERVICE FAUCET, MOP BRACKET, HOSE RACK, STAINLESS STEEL WALL GUARD.	FIAT TS BRASS	TSB3000-MSG B0665-BSTR	3"	2"	3/4"	3/4"
PDI	WATER HAMMER ARRESTOR	SIOUX CHIEF	HYDRA-RESTER			VARIES	VARIES
WCO	WALL CLEAN OUT	WATTS	CO-590-RD	VAF	RIES		
FCO	FLOOR CLEAN OUT, POLISHED BRONZE, COORDINATE FLOORING MATERIALS WITH FINAL FINISH	WATTS	CO-200-P-R	VAF	RIES		
ECO	EXTERIOR CLEAN OUT, HEAVY DUTY ROUND SCORIATED DUCTILE IRON TOP. PROVIDE 18"X4" THICK CONCRETE COLLAR.	WATTS	CO-200P-RX4	VAF	RIES		
FD-1	CAST IRON BODY, FLASHING CLAMP AND ADJUSTABLE SQUARE NICKEL BRONZE TOP, TRAP PRIMER CONNECTION.	ZURN	ZN-415B-P	3" OR 4"	2"	1/2"	
FD-2	EQUIPMENT ROOM FLOOR DRAIN, CAST IRON BODY, FLASHING CLAMP AND ADJUSTABLE NICKEL BRONZE TOP, SEDIMENT BUCKET, TRAP PRIMER	ZURN	ZN-415-7N-P	VARIES	2"	1/2"	
HD-1	COATED CAST IRON BODY, FLASHING CLAMP RAISED FLANGE, GALVANIZED CAST IRON STRAINER.	ZURN	Z-415I-GU	VARIES			
BWV	BACKWATER VALVE (W/ VALVE BOX U/G OR IN SLAB)	WATTS	BV-200	VARIES			
FS-1	FLOOR SINK, 12"X12"X8" DEEP, SQUARE SLOTTED MEDIUM DUTY GRATE, ACID RESISTANT PORCELAIN ENAMEL INTERIOR AND TOP, ALUMINUM DOME STRAINER, TRAP PRIMER CONNECTION, COORDINATE GRATES AND FUNNELS AS INDICATED BY KITCHEN CONSULTANT.	ZURN	Z-1901-32	VARIES	2"	1/2"	
LB-1	WASHING MACHINE SHUT-OFF VALVES MOUNTED IN HIGH IMPACT ENCLOSURE WITH 2" DRAIN CONNECTION. 1/2" HOT AND COLD WATER CONNECTIONS AND 1/4 TURN BALL VALVES, STUD MOUNTING BRACKETS, PROVIDED WITH WATER HAMMER ARRESTORS.	OATEY	38393	2"	1 1/2"	1/2"	1/2"

ELECTRIC WATER HEATER SCHEDULE									
MARK	STORAGE CAPACITY	KW		ELECTRICAL	MANUFACTURER MODEL NO.				
			VOLTS	PHASE	HZ	WARREN NO FORCER (MODELE NO.			
EWH-1-1	40	6.0	277	1	60	STATE PCE 40 20LSA-6			
EWH-1-2	20	4.0	277	1	60	STATE PCE 20 10MSA-4			
EWH-2-1	20	4.0	277	1	60	STATE PCE 20 10MSA-4			
EWH-2-2	20	3.0	277	1	60	STATE PCE 20 10MSA-3			


- PROVIDE A 2 GALLON EXPANSION TANK AND PRE CHARGE TO SYSTEM PRESSURE.
- RECIRCULATION PUMPS RCP-1-1, RCP-1-2, RCP-2-1, RCP-2-2 SHALL HAVE CAPACITY OF 1.0 GPM AT 5' TDH, GRUNDFOS UP 15-10B5, 1/25 HP, 120V/1PH.

MARCO ISLAND **EXECUTIVE AIRPORT** COLLIER COUNTY, FLORIDA



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SCHENKELSHULTZ

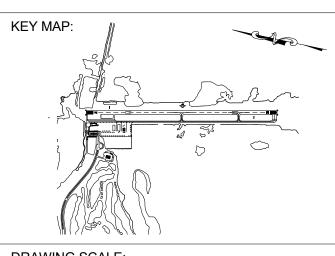

DRAWING SCALE:


	REVISIONS	
MARK	DESCRIPTION	DATE

PROJECT NAME:

NEW TERMINAL FACILITY AND ASSOCIATED **IMPROVEMENTS**

SHEET TITLE:

PLUMBING SYMBOLS AND LEGEND

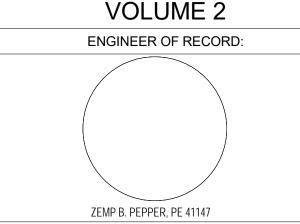


1620729 JOB NO.: DATE: May 2017 DRAWN: DESIGN: CHECKED:

NOTE: GENERAL CONTRACTOR'S (GC) BIDDING SHALL PROVIDE WRITTEN VERIFICATION WITH

THEIR BIDS THAT ALL OF THEIR SUBCONTRACTOR'S BIDDING THIS PROJECT HAVE BECOME FAMILIAR WITH ALL CONSTRUCTION DRAWING SHEETS & PROJECT MANUAL SPECIFICATIONS TO ENSURE THE 6C AND SUB-CONTRACTOR'S CONSTRUCTION BIDS SHALL PROVIDE THE TOTALITY OF THE ENTIRE CONTRACT DOCUMENT REQUIREMENTS.

AVCON, INC. ENGINEERS & PLANNERS 5555 E. MICHIGAN ST., SUITE 200 - ORLANDO, FL 32822-2779 OFFICE: (407) 599-1122 - FAX: (407) 599-1133 CORPORATE CERTIFICATE OF AUTHORIZATION NUMBER: 5057 www.avconinc.com

WALL CLEAN OUT

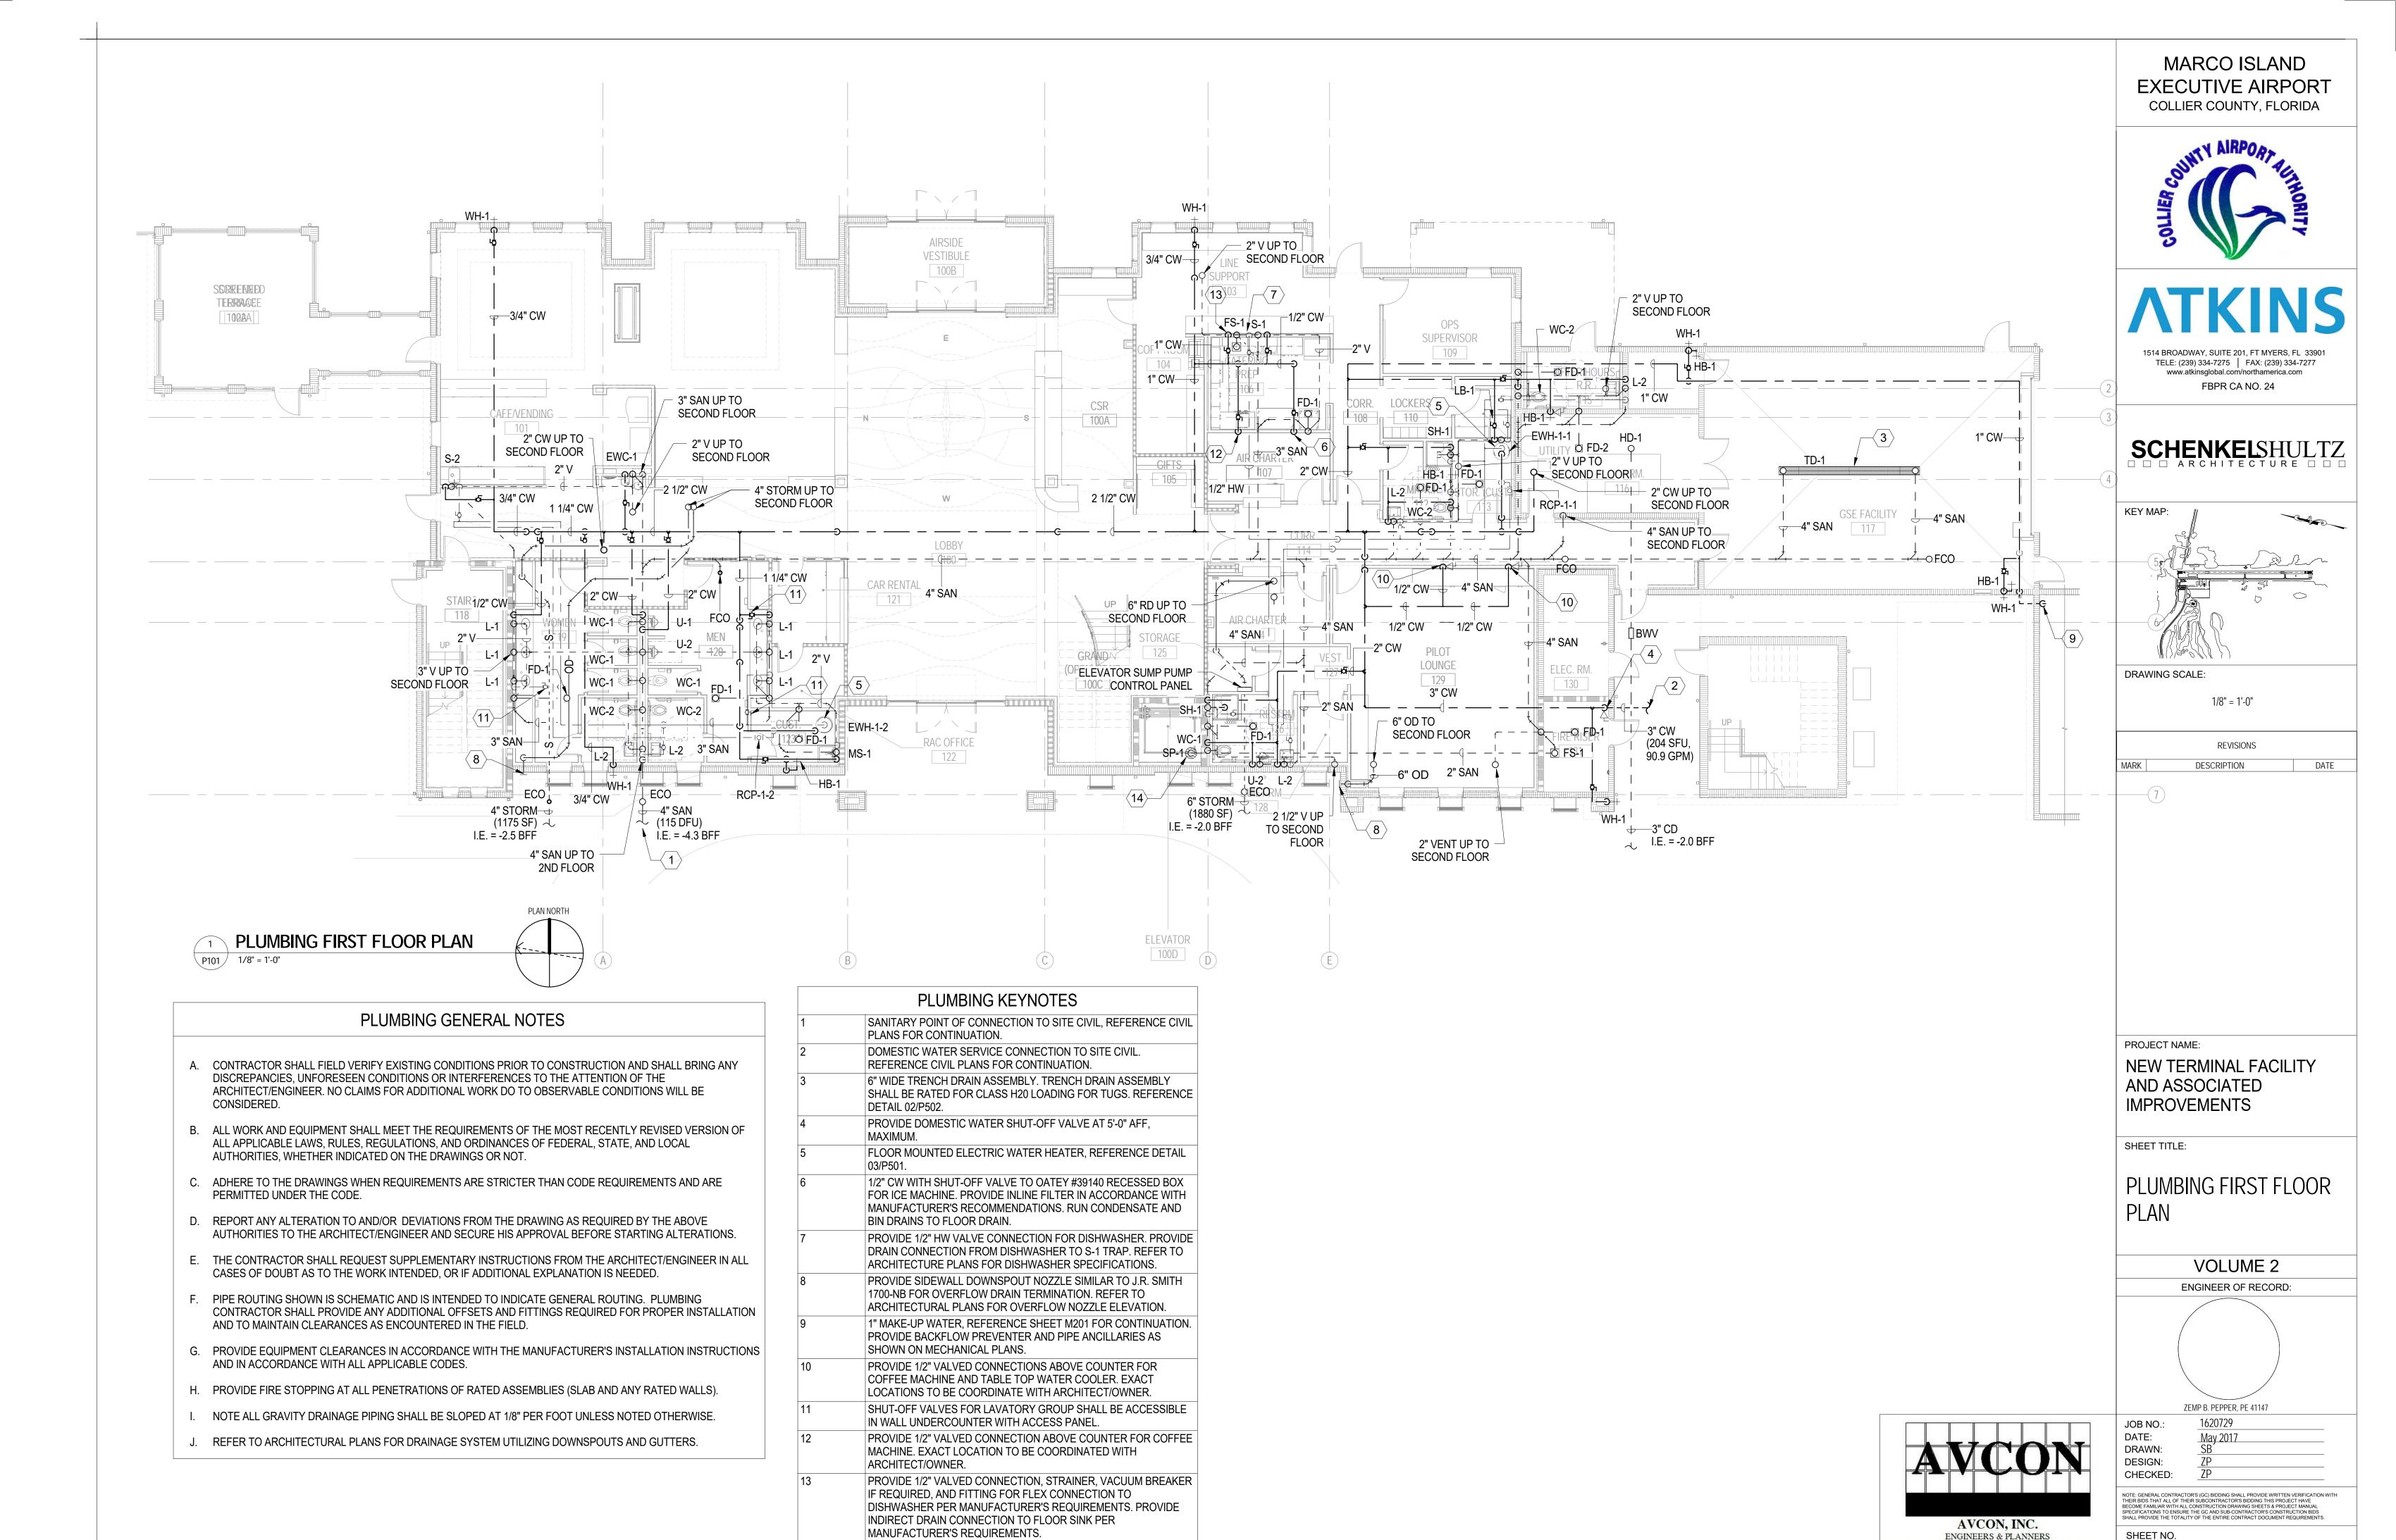


REFERENCE DETAIL 03/P503 FOR ELEVATOR SUMP PUMP

SPECIFICATIONS AND INSTALLATION DETAIL.

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PLUMBING GENERAL NOTES

- A. CONTRACTOR SHALL FIELD VERIFY EXISTING CONDITIONS PRIOR TO CONSTRUCTION AND SHALL BRING ANY DISCREPANCIES, UNFORESEEN CONDITIONS OR INTERFERENCES TO THE ATTENTION OF THE ARCHITECT/ENGINEER. NO CLAIMS FOR ADDITIONAL WORK DO TO OBSERVABLE CONDITIONS WILL BE CONSIDERED.
- B. ALL WORK AND EQUIPMENT SHALL MEET THE REQUIREMENTS OF THE MOST RECENTLY REVISED VERSION OF ALL APPLICABLE LAWS, RULES, REGULATIONS, AND ORDINANCES OF FEDERAL, STATE, AND LOCAL AUTHORITIES, WHETHER INDICATED ON THE DRAWINGS OR NOT.
- C. ADHERE TO THE DRAWINGS WHEN REQUIREMENTS ARE STRICTER THAN CODE REQUIREMENTS AND ARE PERMITTED UNDER THE CODE.
- D. REPORT ANY ALTERATION TO AND/OR DEVIATIONS FROM THE DRAWING AS REQUIRED BY THE ABOVE AUTHORITIES TO THE ARCHITECT/ENGINEER AND SECURE HIS APPROVAL BEFORE STARTING ALTERATIONS.
- E. THE CONTRACTOR SHALL REQUEST SUPPLEMENTARY INSTRUCTIONS FROM THE ARCHITECT/ENGINEER IN ALL CASES OF DOUBT AS TO THE WORK INTENDED, OR IF ADDITIONAL EXPLANATION IS NEEDED.
- F. PIPE ROUTING SHOWN IS SCHEMATIC AND IS INTENDED TO INDICATE GENERAL ROUTING. PLUMBING CONTRACTOR SHALL PROVIDE ANY ADDITIONAL OFFSETS AND FITTINGS REQUIRED FOR PROPER INSTALLATION AND TO MAINTAIN CLEARANCES AS ENCOUNTERED IN THE FIELD.
- G. PROVIDE EQUIPMENT CLEARANCES IN ACCORDANCE WITH THE MANUFACTURER'S INSTALLATION INSTRUCTIONS AND IN ACCORDANCE WITH ALL APPLICABLE CODES.
- H. PROVIDE FIRE STOPPING AT ALL PENETRATIONS OF RATED ASSEMBLIES (SLAB AND ANY RATED WALLS).
- I. NOTE ALL GRAVITY DRAINAGE PIPING SHALL BE SLOPED AT 1/8" PER FOOT UNLESS NOTED OTHERWISE.
- J. REFER TO ARCHITECTURAL PLANS FOR DRAINAGE SYSTEM UTILIZING DOWNSPOUTS AND GUTTERS.

PLUMBING KEYNOTES

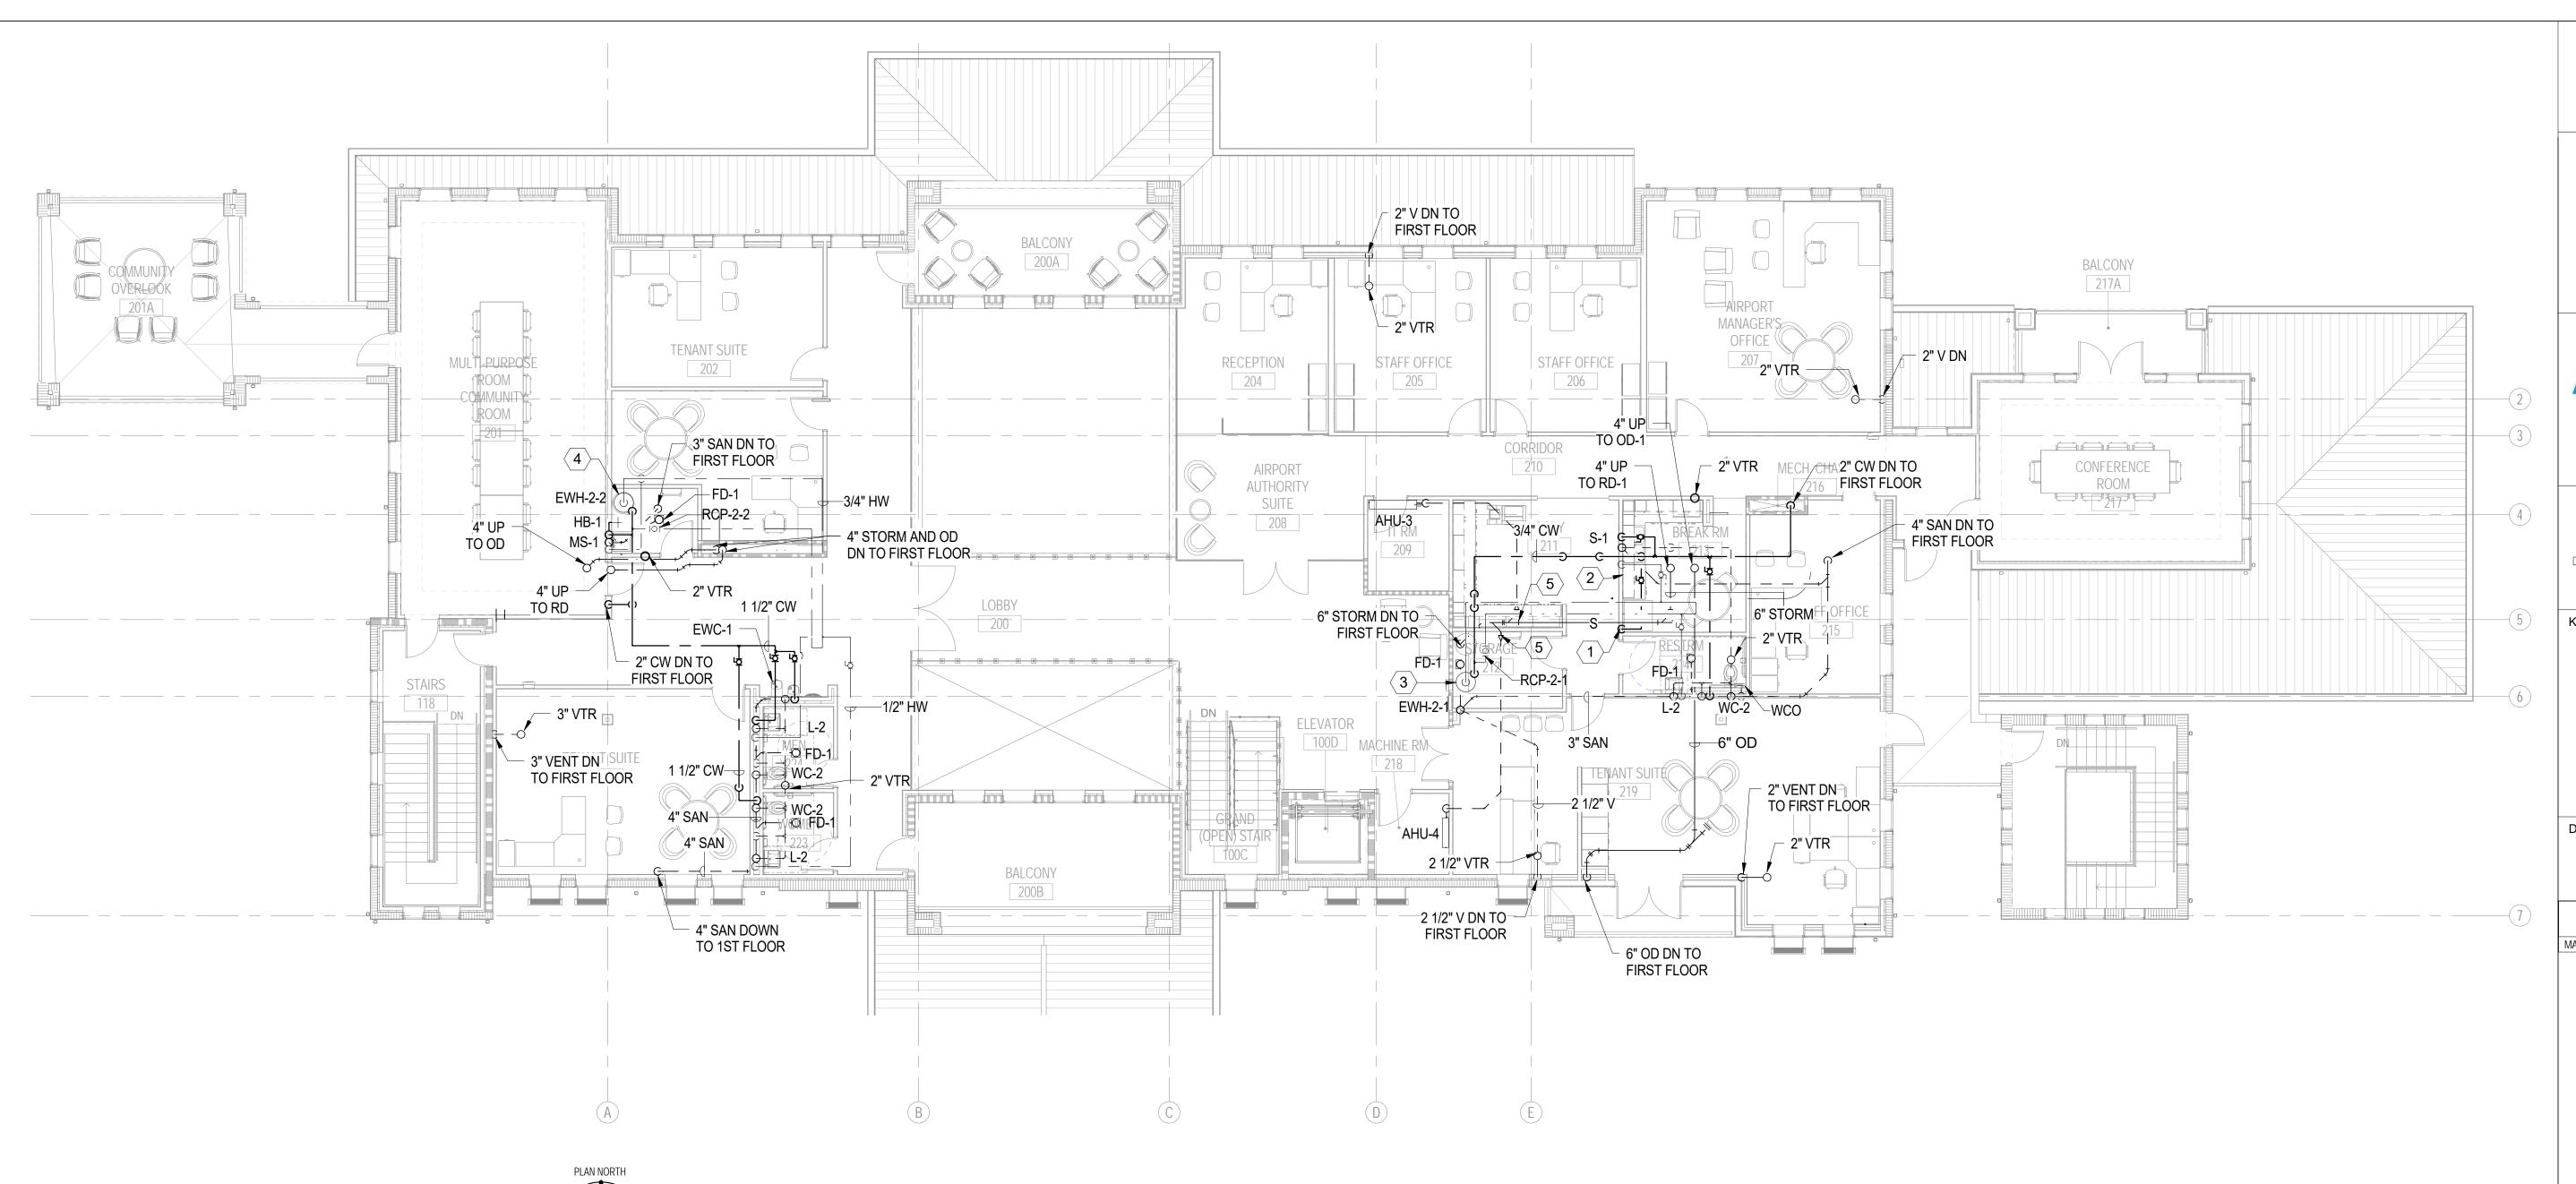1/2" CW WITH SHUT-OFF VALVE TO OATEY #39140
RECESSED BOX FOR REFRIGERATOR ICE MAKER.

PROVIDE 1/2" HW VALVE CONNECTION FOR
DISHWASHER. PROVIDE DRAIN CONNECTION FROM
DISHWASHER TO S-1 TRAP. REFER TO
ARCHITECTURE PLANS FOR DISHWASHER
SPECIFICATIONS.

ELECTRIC WATER HEATER TO BE INSTALLED ON SIDEWALL RACK AND MOUNTED 7' ABOVE FINISHED FLOOR, REFERENCE DETAIL 04/P501.

FLOOR MOUNTED ELECTRIC WATER HEATER,

REFERENCE DETAIL 03/P501.


CONNECT CONDENSATE TO STORM PIPING WITH WYE FITTING."

MARCO ISLAND
EXECUTIVE AIRPORT
COLLIER COUNTY, FLORIDA



ATKINS

SCHENKELSHULTZ

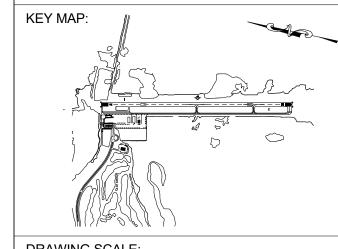

DRAWING SCALE:

1/8" = 1'-0"

REVISIONS

MARK DESCRIPTION DATE

PROJECT NAME:

NEW TERMINAL FACILITY
AND ASSOCIATED
IMPROVEMENTS

SHEET TITLE:

PLUMBING SECOND FLOOR PLAN

VOLUME 2
ENGINEER OF RECORD:

ZEMP B. PEPPER, PE 41147

JOB NO.: 1620729

 JOB NO.:
 1620729

 DATE:
 May 2017

 DRAWN:
 SB

 DESIGN:
 ZP


 CHECKED:
 ZP

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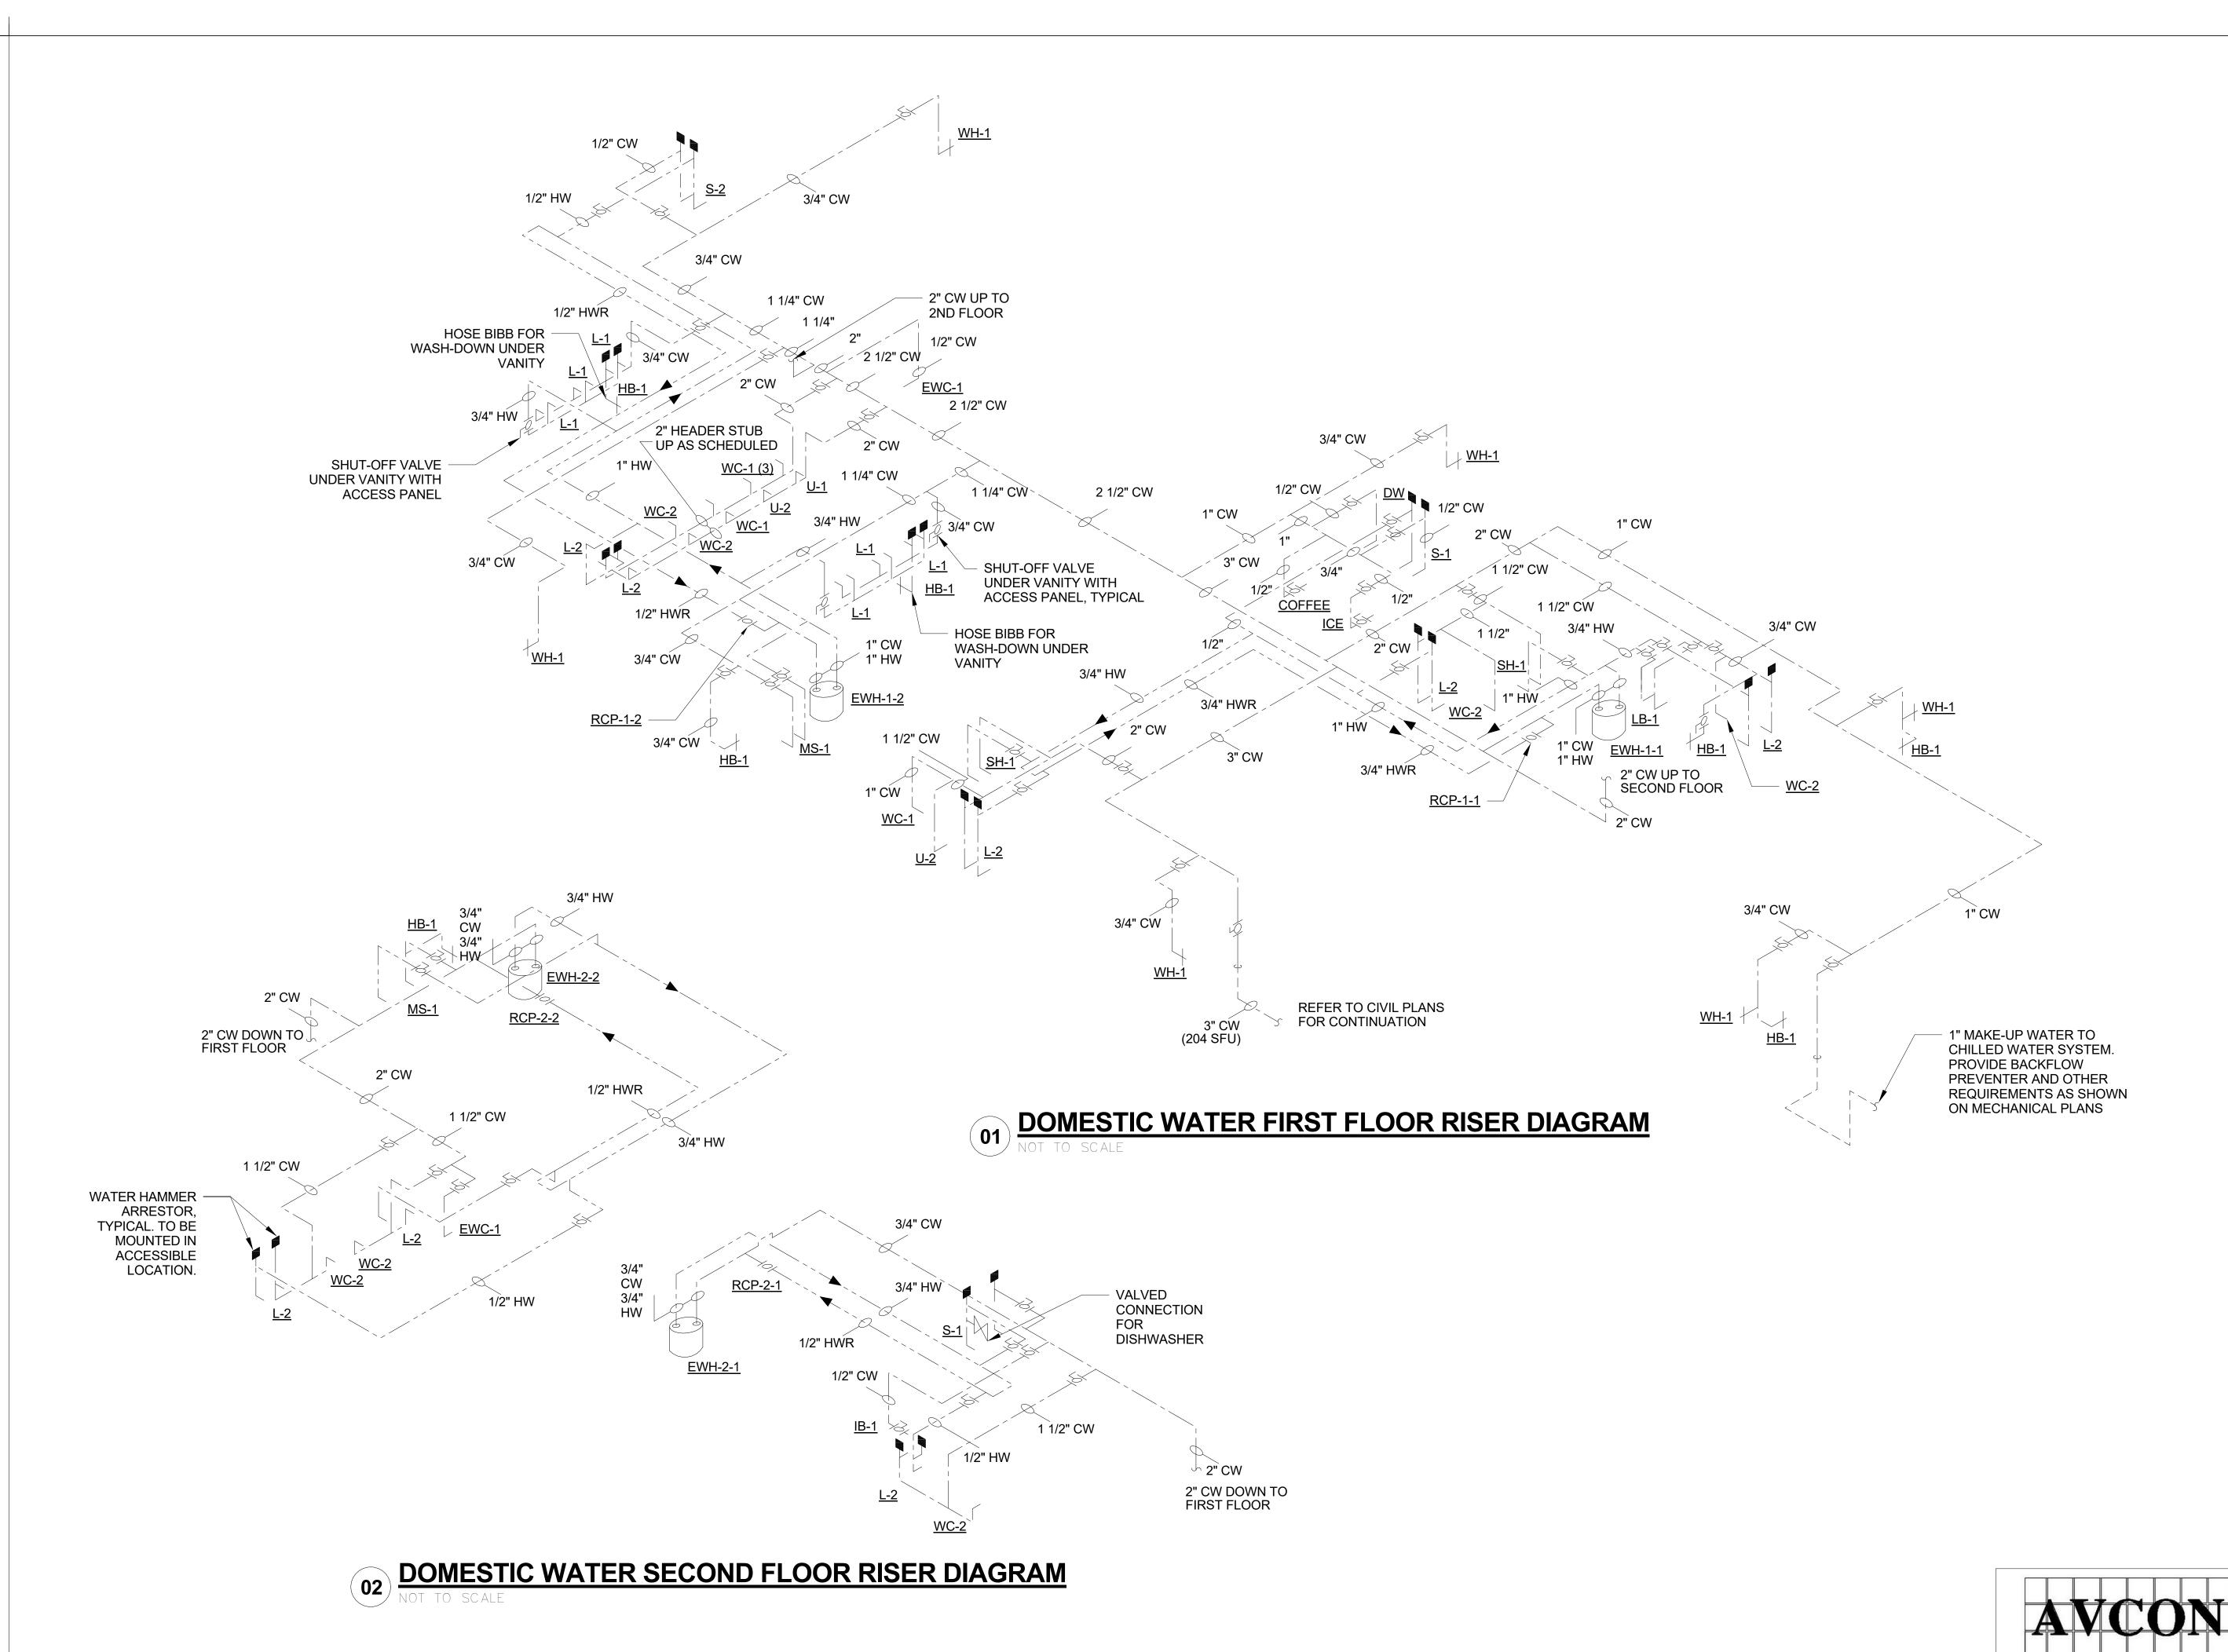
HEET NO.

PLUMBING SECOND FLOOR PLAN

P102 1/8" = 1'-0"

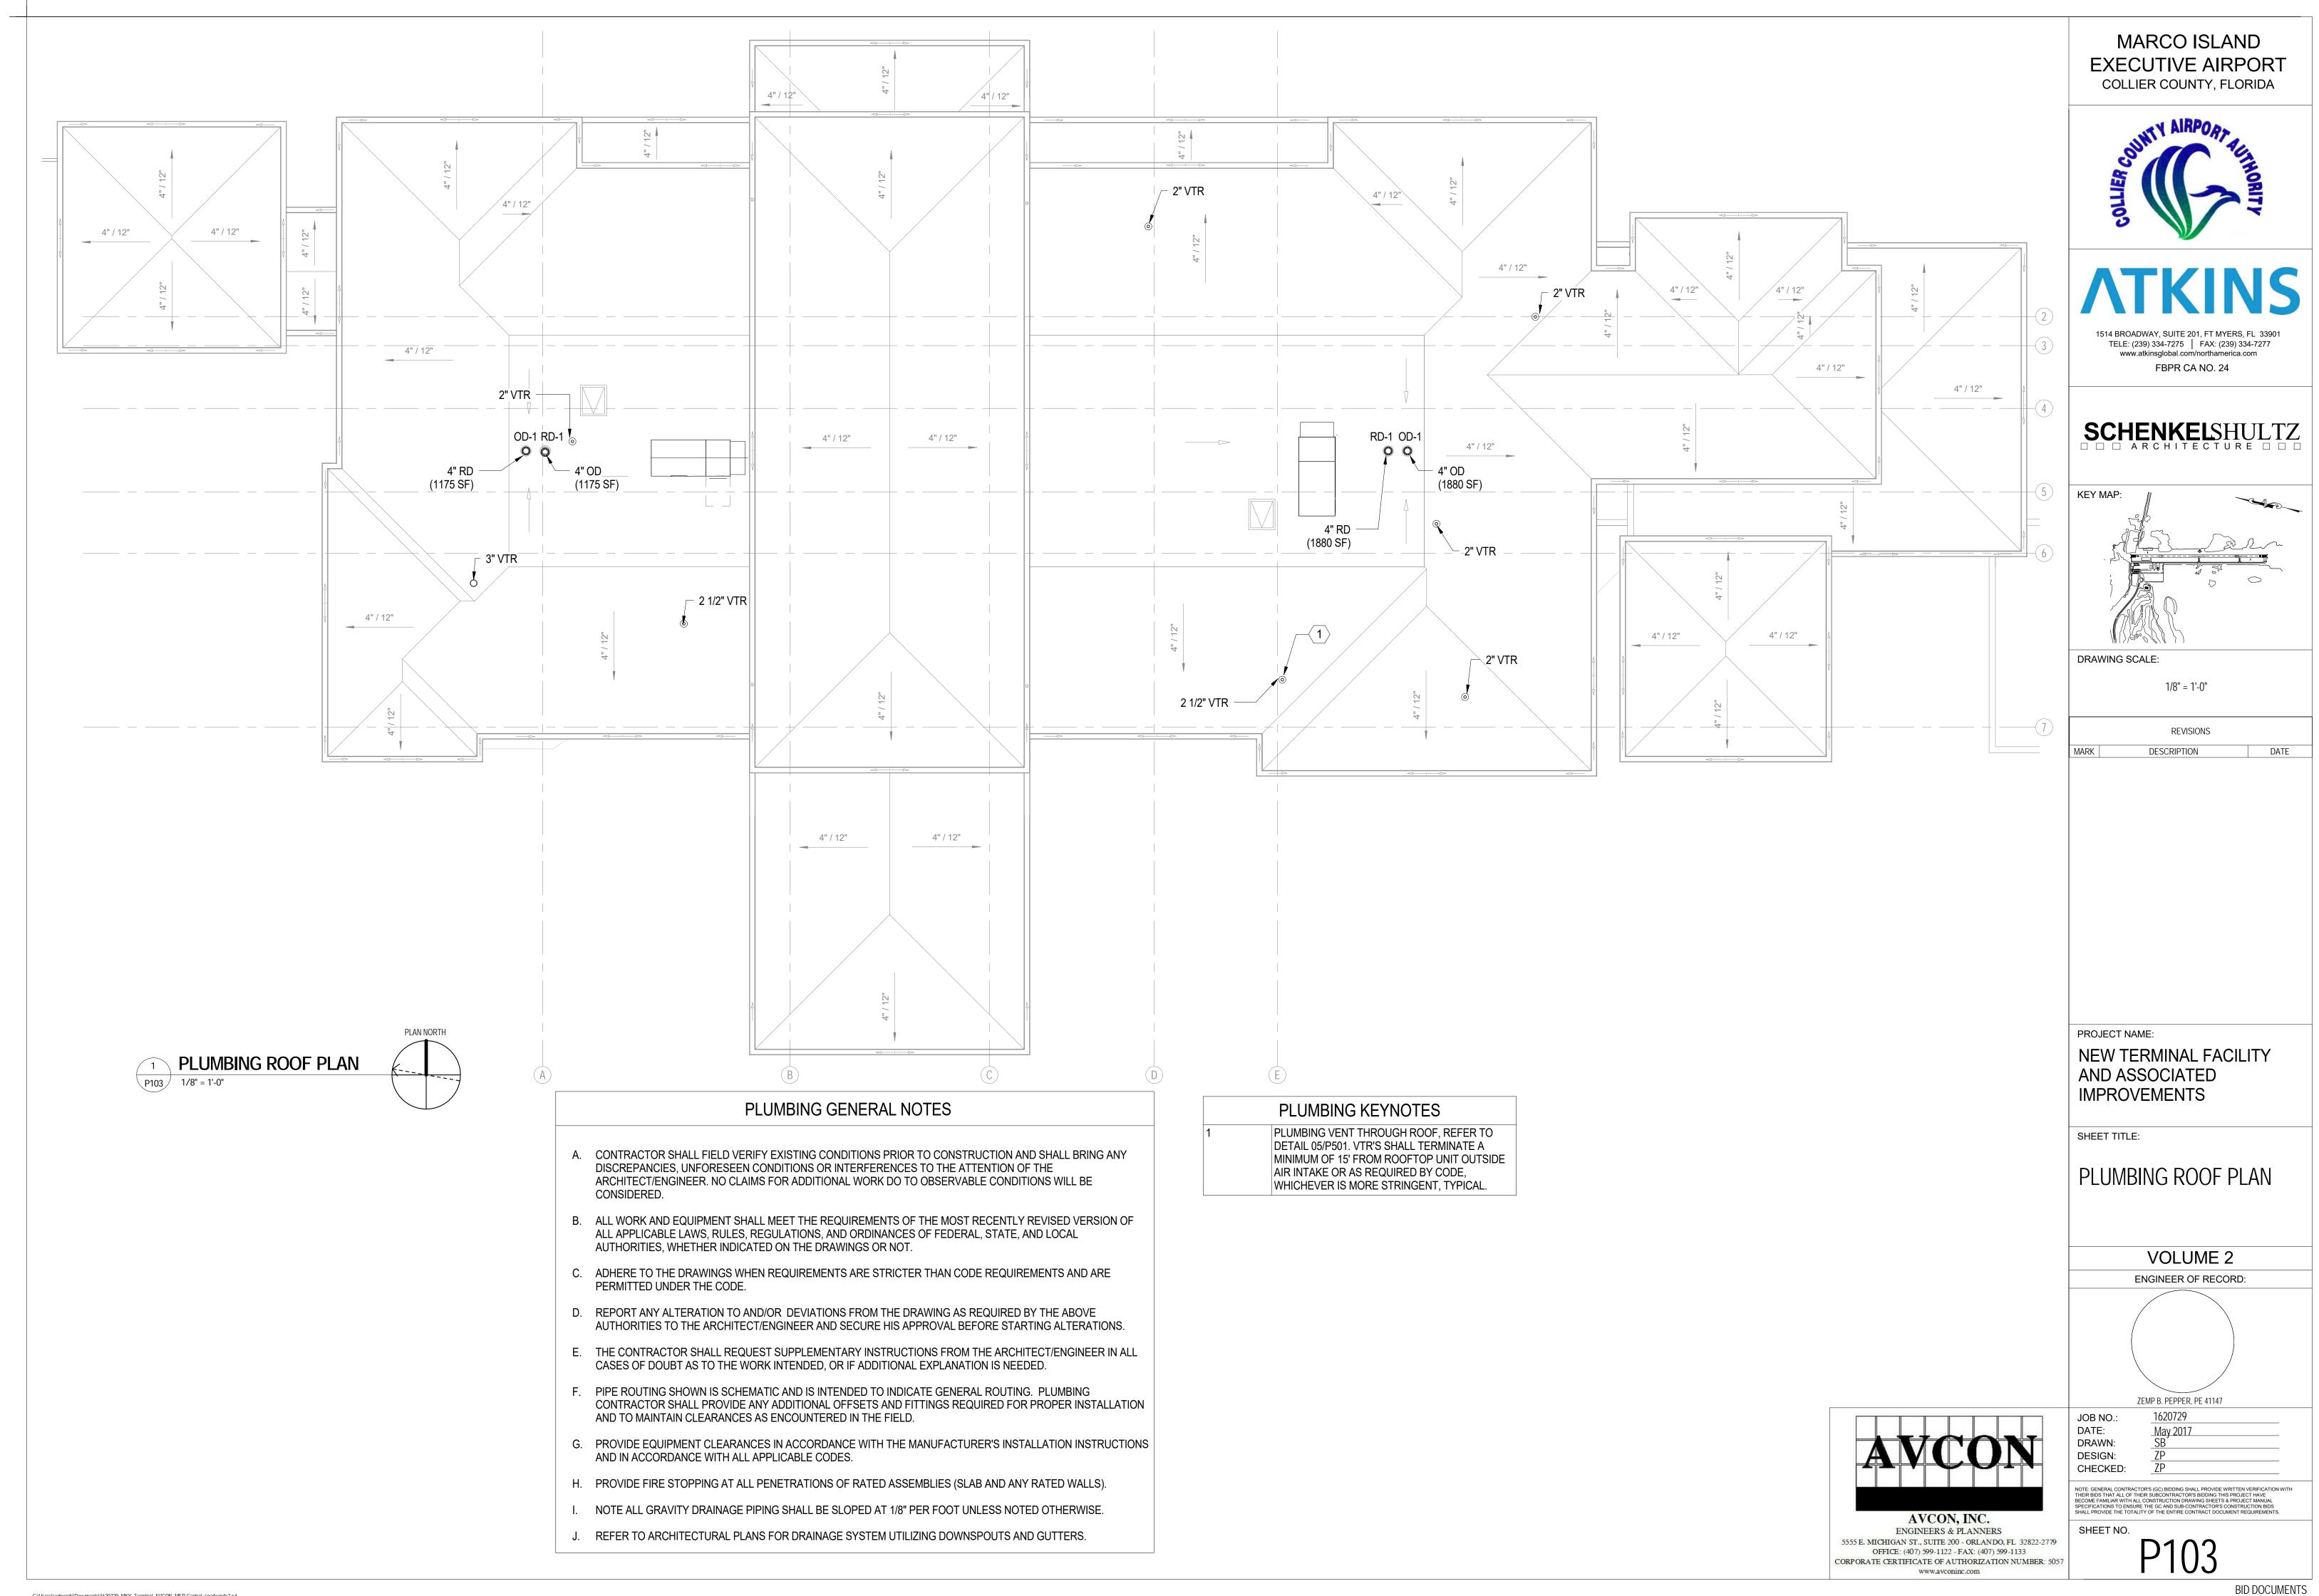

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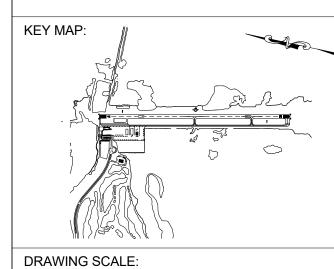
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FBPR CA NO. 24

SCHENKELSHULTZ



12" = 1'-0" REVISIONS

DESCRIPTION DATE

PROJECT NAME: NEW TERMINAL FACILITY

AND ASSOCIATED **IMPROVEMENTS**

SHEET TITLE:

PLUMBING RISERS


VOLUME 2

ENGINEER OF RECORD: ZEMP B. PEPPER, PE 41147


1620729 DATE: DRAWN: DESIGN: CHECKED:

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01 FIRST FLOOR SANITARY RISER DIAGRAM NOT TO SCALE




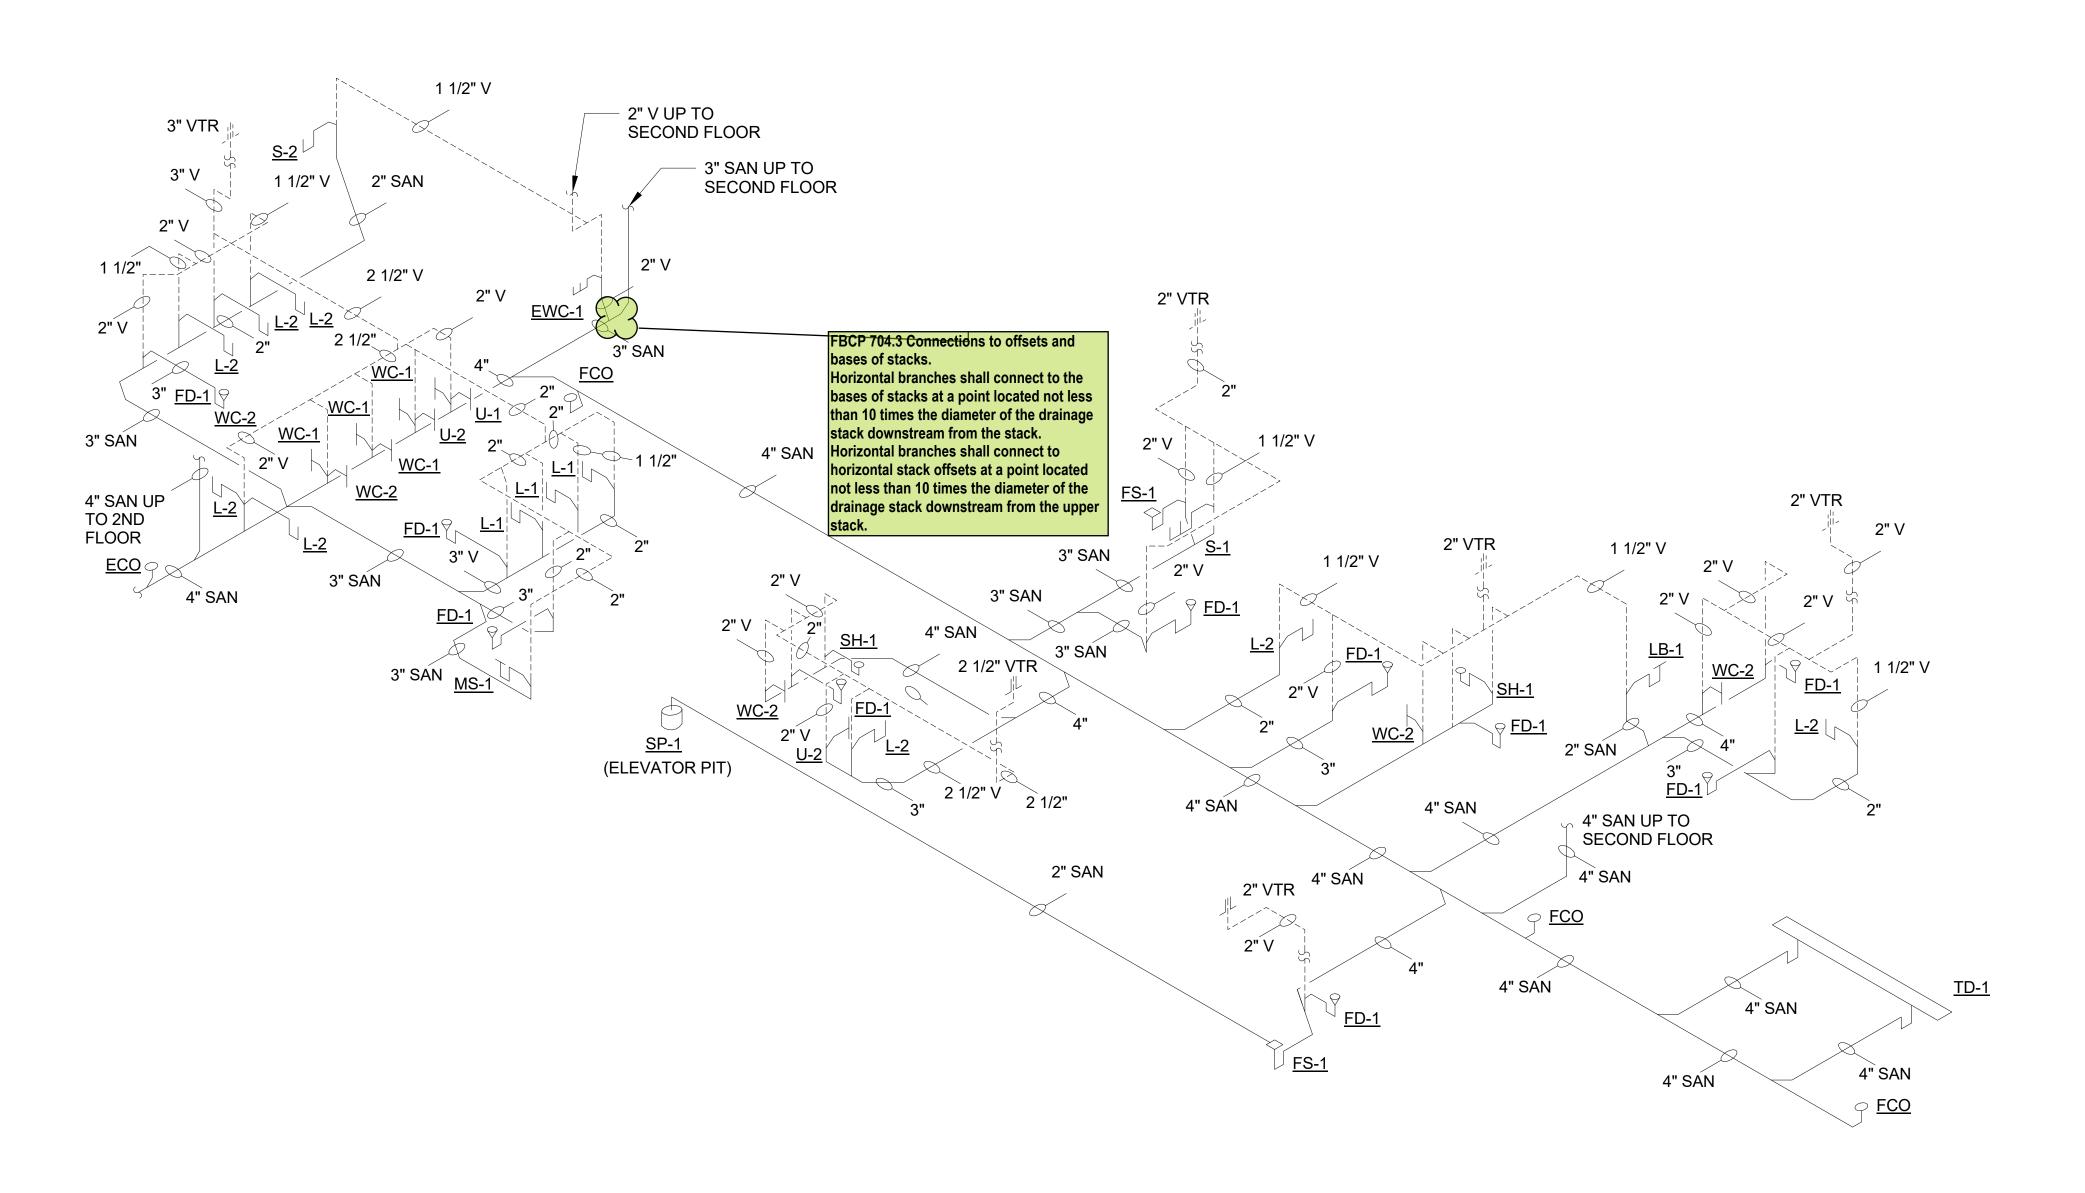

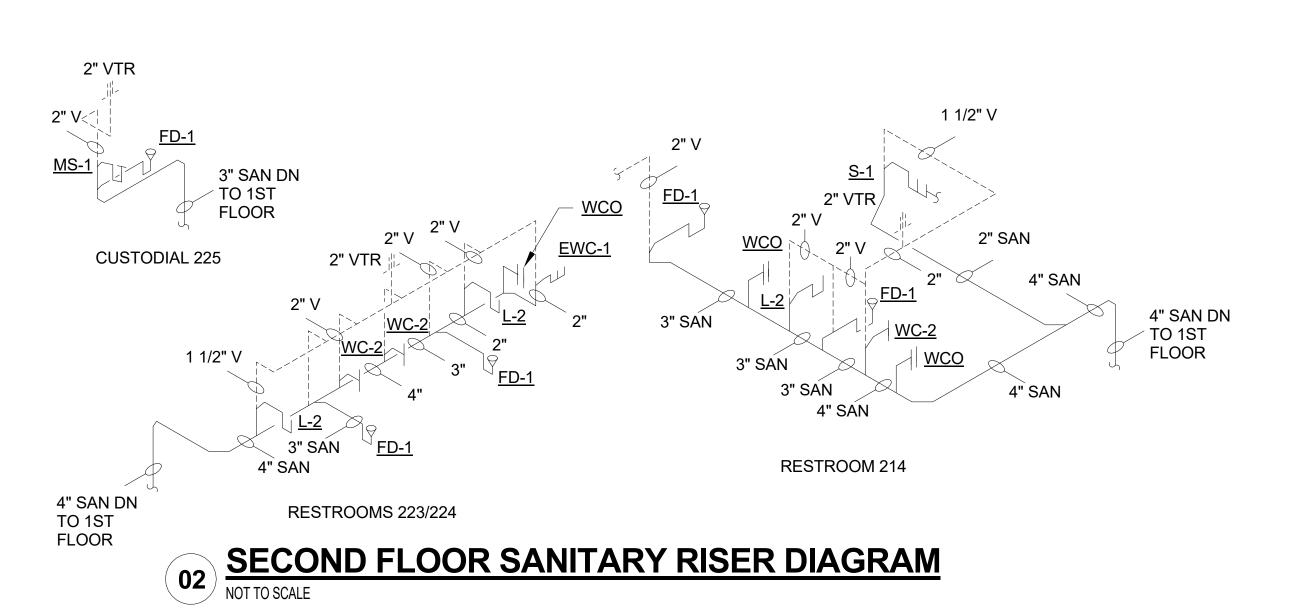

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SCHENKELSHULTZ ARCHITECTURE | |

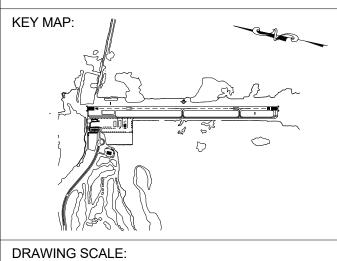

12" = 1'-0"

REVISIONS DESCRIPTION DATE


PROJECT NAME: NEW TERMINAL FACILITY

AND ASSOCIATED **IMPROVEMENTS**

SHEET TITLE:

PLUMBING RISERS

VOLUME 2 ENGINEER OF RECORD:

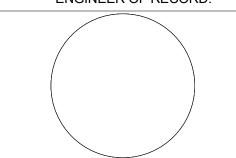


PETER CZUTRIN, PE 82478 1620729


DATE: DRAWN: May 2017 Author DESIGN: CHECKED:

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AVCON, INC. ENGINEERS & PLANNERS 5555 E. MICHIGAN ST., SUITE 200 - ORLANDO, FL 32822-2779 OFFICE: (407) 599-1122 - FAX: (407) 599-1133 CORPORATE CERTIFICATE OF AUTHORIZATION NUMBER: 5057 www.avconinc.com

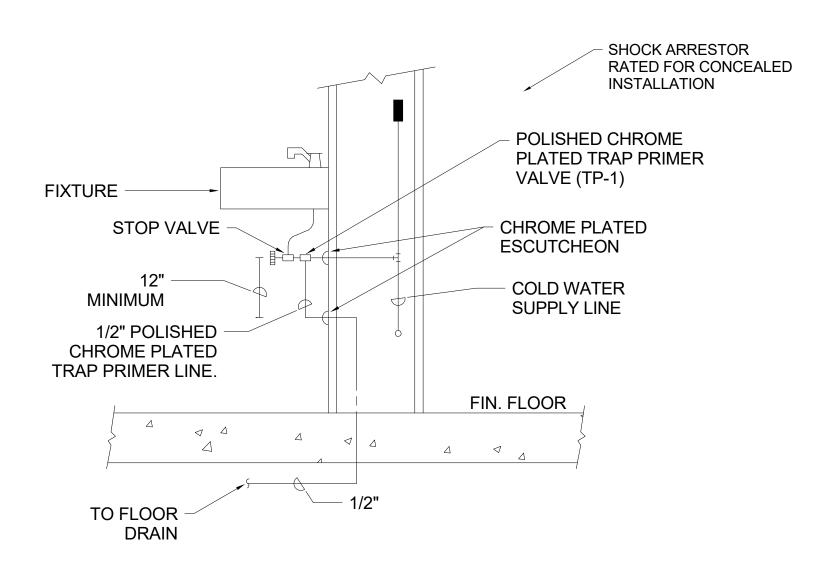

TRAP PRIMER (TP-1) DETAIL

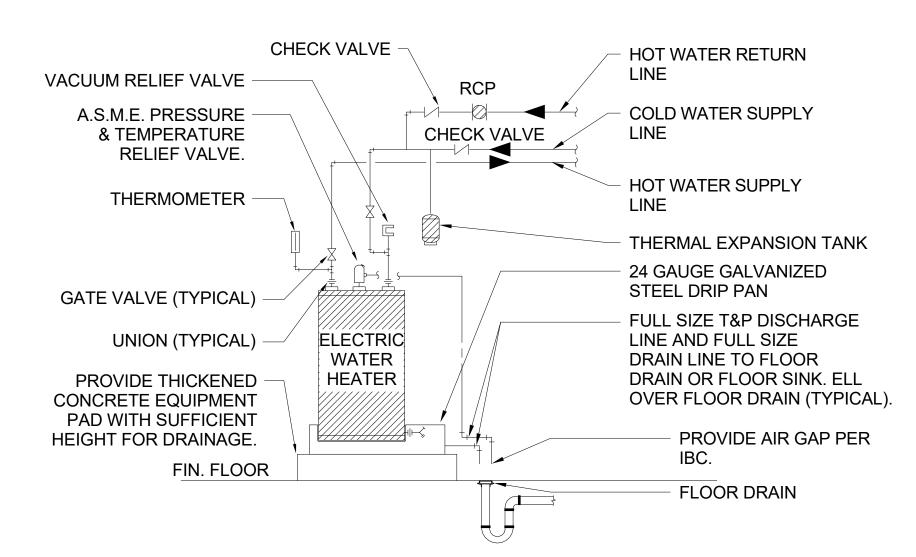


ELECTRIC WATER HEATER PIPING DIAGRAM


NOT TO SCALE

1. ALL PIPING SHALL BE SECURED TO MAKE RIGID.

2. ALL LINES TO BE FULL SIZE TO POINT OF CONNECTION AT HEATER.

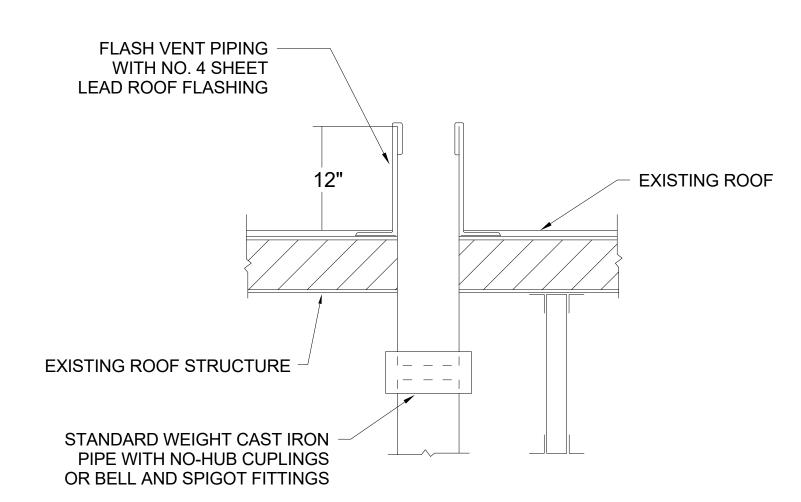


VENT PENETRATION THROUGH ROOF DETAIL

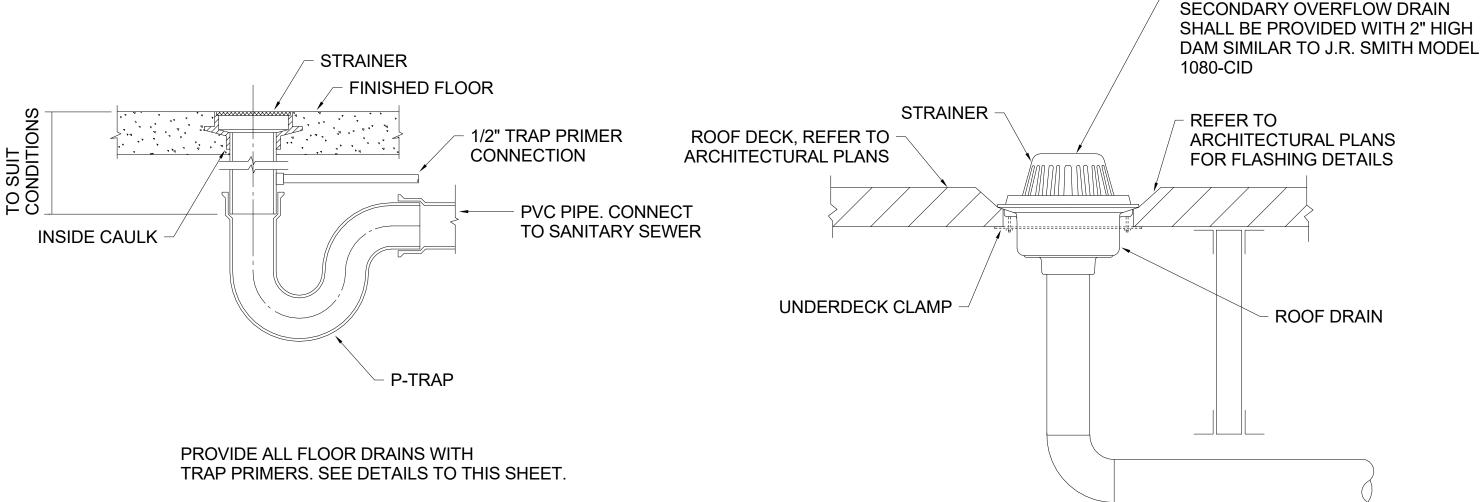

FLOOR DRAIN DETAIL



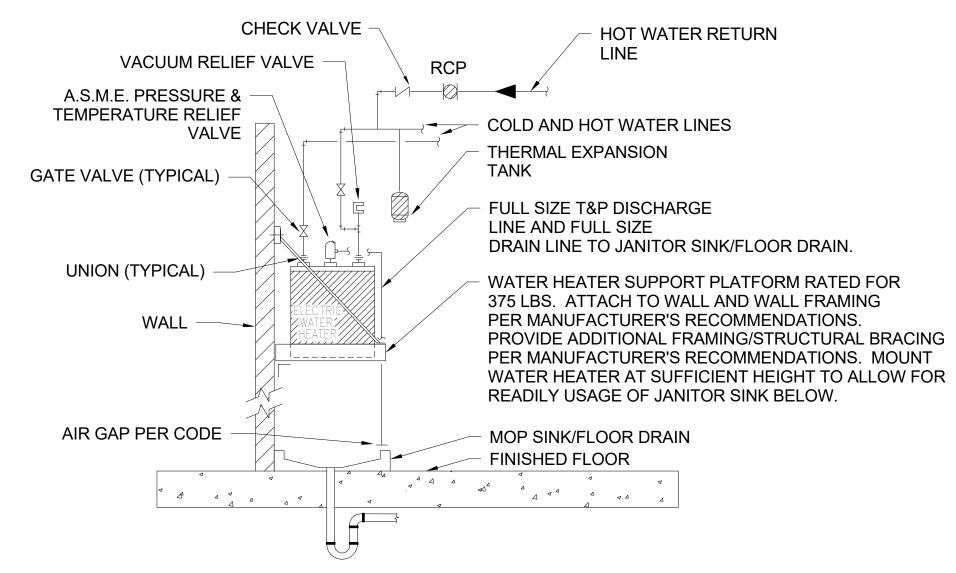


ELEVATED ELECTRIC WATER HEATER PIPING DIAGRAM

NOT TO SCALE

1. ALL PIPING SHALL BE SECURED TO MAKE RIGID.

2. ALL LINES TO BE FULL SIZE TO POINT OF CONNECTION AT HEATER.

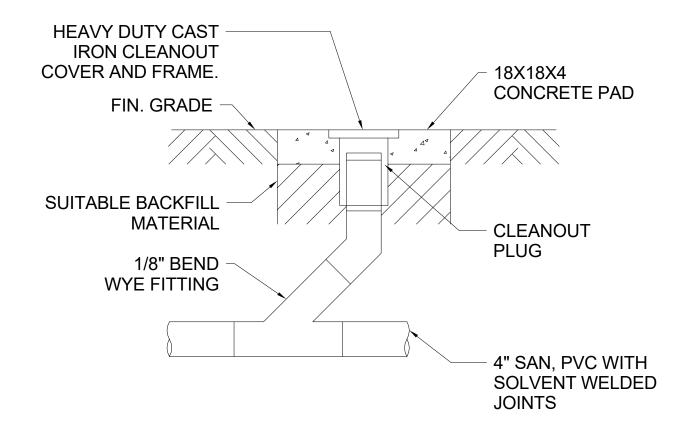


EXTERIOR CLEANOUT DETAIL

ROOF DRAIN, J.R. SMITH 1010-CID. MARCO ISLAND **EXECUTIVE AIRPORT** COLLIER COUNTY, FLORIDA



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SCHENKELSHULTZ

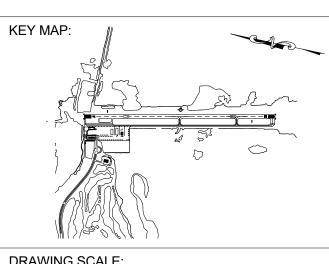

DRAWING SCALE:

12" = 1'-0"

REVISIONS DESCRIPTION DATE

PROJECT NAME:

NEW TERMINAL FACILITY AND ASSOCIATED **IMPROVEMENTS**

SHEET TITLE:

PLUMBING DETAILS


VOLUME 2 ENGINEER OF RECORD:

ZEMP B. PEPPER, PE 41147 1620729 JOB NO. DATE: May 2017 DRAWN: DESIGN: CHECKED:

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OFFICE: (407) 599-1122 - FAX: (407) 599-1133 CORPORATE CERTIFICATE OF AUTHORIZATION NUMBER: 5057



System No.W-L-5010 May 19, 2005 F Rating - 2 Hr. T Rating - 1-1/2 Hr. L Rating At Ambient - 2 CFM/sq ft L Rating At 400 F - less than 1 CFM/sq ft

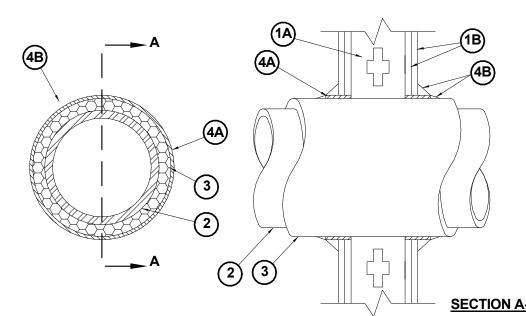NOTE:

THIS MATERIAL WAS EXTRACTED BY 3M FIRE PROTECTION PRODUCTS FROM THE 2004 EDITION OF THE UL FIRE RESISTANCE DIRECTORY.

- 1. Wall Assembly The 1 or 2 hr fire-rated gypsum wallboard/stud wall assembly shall be constructed of the materials and in the manner described in the individual U300, U400 or V400 Series Wall or Partition Design in the UL Fire Resistance Directory and shall include the following construction features:
- A. Studs Wall framing may consist of either wood studs or steel channel studs. Wood studs to consist of nom 2 in. by 4 in. (25 mm by 102 mm) lumber spaced 16 in. (406 mm) OC with nom 2 by 4 in. lumber end plates and cross braces. Steel studs to be min 3-5/8 in. (92 mm) wide by 1-3/8 in. (35 mm) deep channels spaced max 24 in. (610 mm) OC.
- B. Gypsum Board* Nom 5/8 in. (16 mm) thick, 4 ft (122 cm) wide with square or tapered edges. The gypsum wallboard type, thickness, number of layers, fastener type and sheet orientation shall be as specified in the individual U300 or U400 Series Design in the UL Fire Resistance Directory. Max diam of opening is 14-1/2 in (368 mm) for wood stud walls and 18 in. (457 mm) for steel stud walls.

The hourly F Rating of the firestop system is 1 hr when installed in a 1 hr fire rated wall and 2 hr when installed in a 2 hr fire rated wall.

- 2. Through Penetrants One metallic pipe or tubing to be centered within the firestop system. Pipe or tubing to be rigidly supported on both sides of wall assembly. The following types and sizes of metallic pipes or tubing may be used:
- A. Steel Pipe Nom 12 in. (305 mm) diam (or smaller) Schedule 10 (or heavier) steel pipe.
- B. Copper Tubing Nom 6 in. (152 mm) diam (or smaller) Type L (or heavier) copper tubing.
- C. Copper Pipe Nom 6 in. (152 mm) diam (or smaller) Regular (or heavier) copper pipe.
- 3. Pipe Covering* Nom 1 in. or 2 in. (25 mm or 51 mm) thick hollow cylindrical heavy density glass fiber units jacketed on the outside with an all service jacket. Longitudinal joints sealed with metal fasteners or factory-applied self-sealing lap tape. Transverse joints sealed with metal fasteners or with butt strip tape supplied with the product. When nom 1 in. (25 mm) thick pipe covering is used, the annular space between the pipe covering and the circular cutout in the gypsum wallboard layers on each side of the wall shall be min 1/4 in. to max 3/8 in. (6 mm to max 10 mm). When nom 2 in. (51 mm) thick pipe covering is used, the annular space between the pipe covering and the circular cutout in the gypsum wallboard layers on each side of the wall shall be min 1/2 in. to max 3/4 in. (13 mm to max 19 mm).

See Pipe and Equipment Covering - Materials (BRGU) category in Building Materials Directory for names of manufacturers. Any pipe covering material meeting the above specifications and bearing the UL Classification Marking with a Flame Spread Index of 25 or less and a Smoke Developed Index of 50 or less may be used.

The hourly T Rating of the firestop system is 3/4 hr when nom 1 in. (25 mm) thick pipe covering is used.

The hourly T Rating of the firestop system is 1 hr and 1-1/2 hr when nom 2 in. (51 mm) thick pipe covering is used with 1 hr and 2 hr fire rated walls, respectively.

- 4. Firestop System Installed symmetrically on both sides of wall assembly. The details of the firestop system shall be as follows:
- A. Fill, Void or Cavity Materials* Wrap Strip Nom 1/4 in. (6 mm) thick intumescent elastomeric material faced on one side with aluminum foil, supplied in 2 in. (51 mm) wide strips. Nom 2 in. (51 mm) wide strip tightly wrapped around pipe covering (foil side out) with seam butted. Wrap strip layer securely bound with steel wire or aluminum foil tape and slid into annular space approx 1-1/4 in. (32 mm) such that approx 3/4 in. (19 mm) of the wrap strip width protrudes from the wall surface. One layer of wrap strip is required when nom 1 in. (25 mm) thick pipe covering is used. Two layers of wrap strip are required when nom 2 in. (51 mm) thick pipe covering is used.


3M COMPANY - FS-195+

B. Fill, Void or Cavity Materials* - Caulk or Sealant - Min 1/4 in. (6 mm) diam continuous bead applied to the wrap strip/wall interface and to the exposed edge of the wrap strip layer approx 3/4 in. (19 mm) from the wall surface.


3M COMPANY - CP 25WB+, IC 15WB+, FireDam 150+ caulk or FB-3000 WT sealant

*Bearing the UL Classification Marking


FIRESTOP SYSTEM-GYMPSUM BOARD WALL INSULATED METAL PIPE

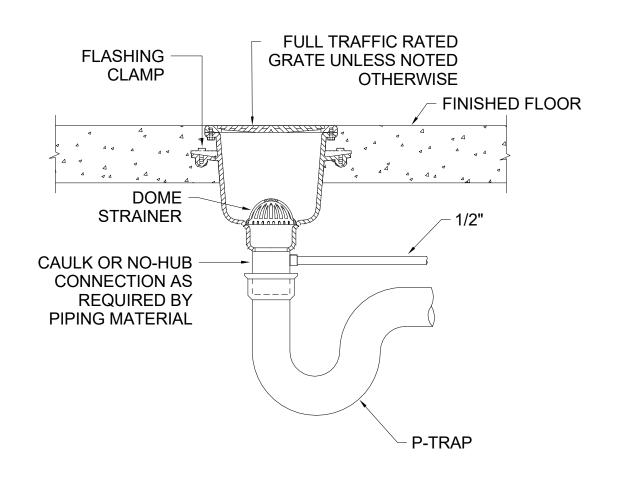




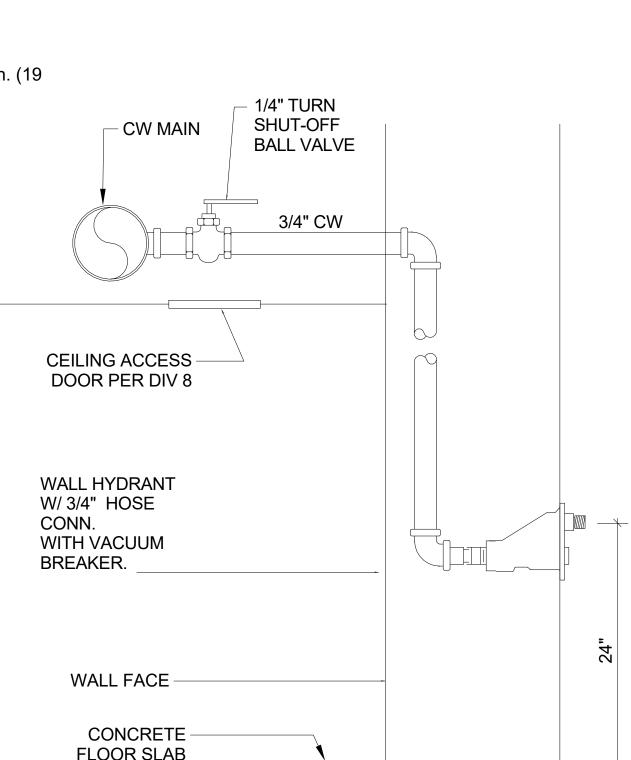



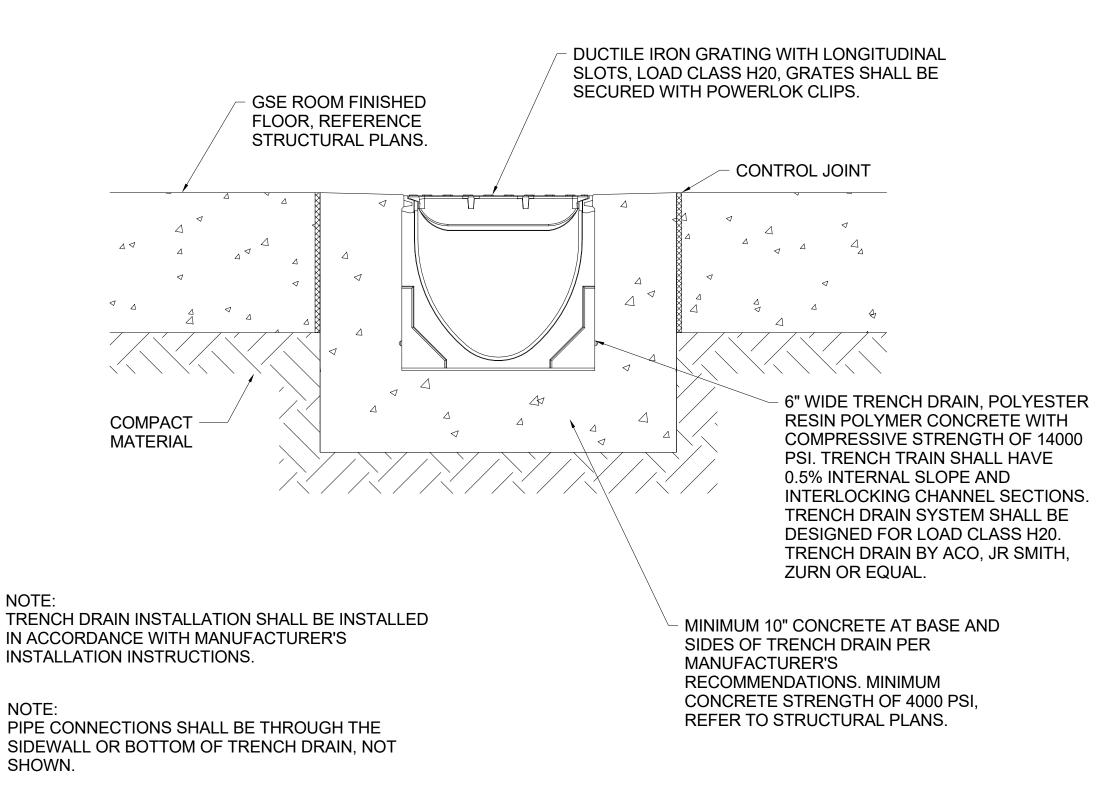

TRENCH DRAIN DETAIL

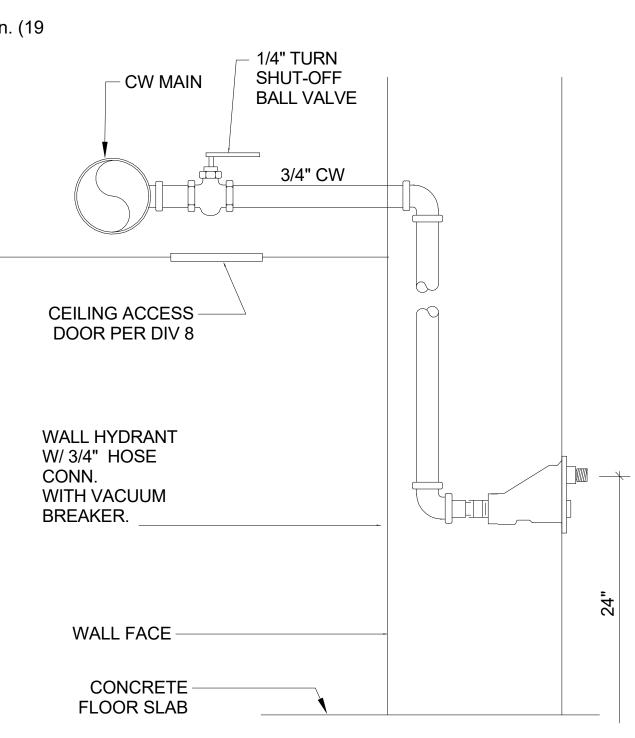




MARCO ISLAND

EXECUTIVE AIRPORT

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SCHENKELSHULTZ

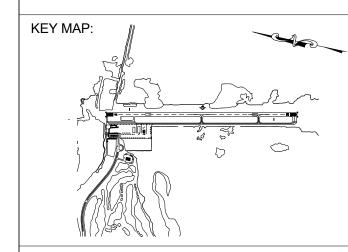

DRAWING SCALE:

REVISIONS

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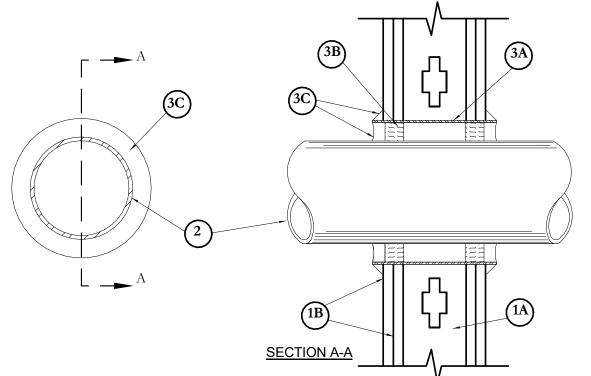
SHEET TITLE:

PLUMBING DETAILS

VOLUME 2 ENGINEER OF RECORD: ZEMP B. PEPPER, PE 41147

1620729 DATE: DRAWN: DESIGN: CHECKED: THEIR BIDS THAT ALL OF THEIR SUBCONTRACTOR'S BIDDING THIS PROJECT HAVE BECOME FAMILIAR WITH ALL CONSTRUCTION DRAWING SHEETS & PROJECT HANUAL SPECIFICATIONS TO ENSURE THE GC AND SUB-CONTRACTOR'S CONSTRUCTION BIDS SHALL PROVIDE THE TOTALITY OF THE ENTIRE CONTRACT DOCUMENT REQUIREMENT

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System No.W-L-1003 September 03, 2004 (Formerly System No. 147) F Ratings - 1 and 2 Hr (See Item 1) T Rating - 0 Hr


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- A. Studs Wall framing may consist of either wood studs or steel channel studs. Wood studs to consist of nom 2 by 4 in. lumber spaced 16 in. OC with nom 2 by 4 in. lumber end plates and cross braces. Steel studs to be min 3-1/2 in. wide by 1-3/8 in. deep channels spaced max 24 in. OC.
- B. Gypsum Board* Nom 5/8 in. thick, 4 ft. wide with square or tapered edges. The gypsum wallboard type, thickness, number of layers, fastener type and sheet orientation shall be as specified in the individual U300 or U400 Series Design in the UL Fire Resistance Directory. Max diam of opening is 15 in.
- The hourly F Rating of the firestop system is equal to the hourly fire rating of the wall assembly in which it is installed.
- 2. Through Penetrant One metallic pipe, conduit or tubing to be installed either concentrically or eccentrically within the firestop system. The space between pipes, conduits or tubing and the steel sleeve (Item 3A) shall be min of 0 in. (point contact) to max 2-3/8 in. Pipe, conduit or tubing to be rigidly supported on both sides of wall assembly. The following types and sizes of metallic pipes, conduits or tubing may be used:
- A. Steel Pipe Nom 12 in. diam (or smaller) Schedule 10 (or heavier) steel pipe.
- B. Iron Pipe Nom 12 in. diam (or smaller) service weight (or heavier) cast iron soil pipe, nom 12 in. diam (or smaller) or Class 50 (or heavier)
- C. Conduit Nom 6 in. diam (or smaller) steel conduit or nom 4 in. diam (or smaller) steel electrical metallic tubing.
- D. Copper Tubing Nom 6 in. diam (or smaller) Type L (or heavier) copper tubing.
- E. Copper Pipe Nom 6 in. diam (or smaller) Regular (or heavier) copper pipe.
- 3. Firestop System Installed symmetrically on both sides of wall assembly. The details of the firestop system shall be as follows.
- A. Steel Sleeve Cylindrical sleeve fabricated from min 0.019 in. thick (No. 28 gauge) galv sheet steel and having a min 2 in. lap along the longitudinal seam. Length of steel sleeve to be equal to thickness of wall plus 1 to 4 in. such that, when installed, the ends of the sleeve will project approximately 1/2 to 2 in. beyond the surface of the wall on both sides of the wall assembly. Sleeve installed by coiling the sheet steel to a diam smaller than the through opening, inserting the coil through the openings and releasing the coil to let it uncoil against the circular cutouts in the gypsum wallboard layers.
- B. Packing Material Min 1 in. thickness of mineral wool batt insulation firmly packed into steel sleeve on both sides of the wall assembly as permanent forms. Packing material to be recessed min 1/2 in. from end of steel sleeve (flush with or recessed into gypsum wallboard surface) on both sides of wall assembly.
- B1. Packing Material (Not shown) As an alternate to Item B, nom 1 in. thick polyethylene backer rod may be used. The backer rod is to be recessed within the steel sleeve a min of 1 in. from each surface of wall.
- C. Fill, Void or Cavity Materials* Caulk or Sealant When mineral wool batt insulation is used, applied to fill the steel sleeve to a min depth of 1/2 in. on both sides of wall assembly. When backer rod is used, a min thickness of 1 in. of CP-25WB+ caulk is required flush with surface of wall. A nom 1/4 in. diam continuous bead of caulk or sealant shall be applied around the circumference of the steel sleeve at its egress from the gypsum wallboard layers on both sides of the wall assembly.

3M COMPANY - CP 25WB+ caulk or FB-3000 WT sealant.

*Bearing the UL Classification Marking

FIRESTOP SYSTEM-GYMPSUM BOARD WALL UN-INSULATED METAL PIPE

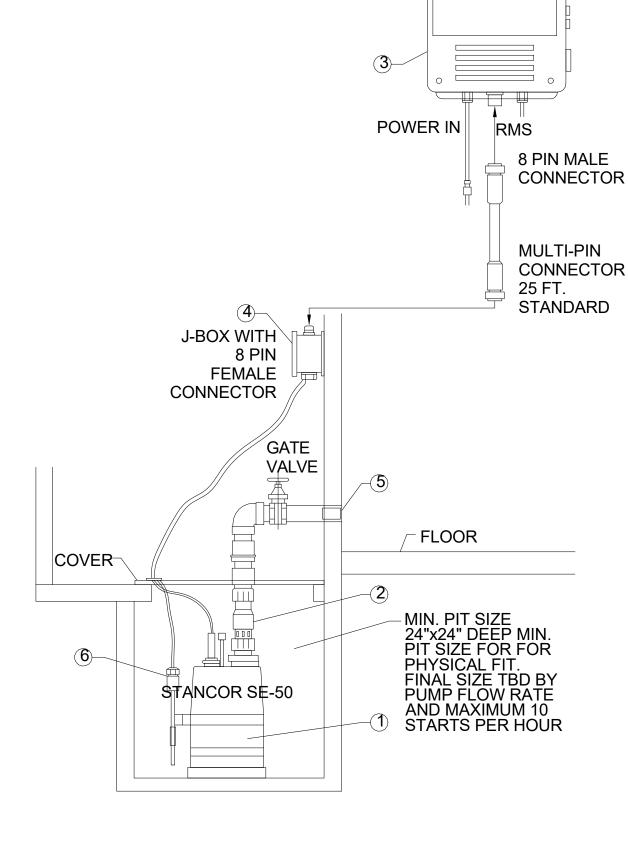

NOTES:

OIL-MINDER

MULTI-OPTION

- $^{ extstyle 1)}$ STANCOR MODEL SE50 SUBMERSIBLE EFFLUENT PUMP 1/2 HP, 115 VOLT, 3600 RPM, 2" DISCHARGE (STD) CONNECTION
- (2) STANCOR 2" CHECK VALVE.
- (3) STANCOR OIL MINDER 115V, 1Ø CONTROL SYSTEM WITH OPTIONAL BUILT IN AUDIBLE AND VISUAL ALARM WHEN PUMP DOES NOT RUN DUE TO OIL IN PIT OR HIGH LIQUID ALARM. PROVIDE SILENCING BUTTON FOR AUDIBLE ALARM BUILT INTO PANEL. PANEL SHALL HAVE ADDITIONAL CONTACT FOR A REMOTE ALARM LOCATION. JUNCTION BOX WILL BE PROVIDED WITH MULTI-PIN CONNECTOR & CORD IN LENGTHS AS REQUIRED. 25FT IS STANDARD. OPTIONAL 25FT INCREMENTS. LIGHTS FOR OIL SPILL, POWER HIGH LIQUID LEVEL OVERLOAD & PUMP RUN
- 4 JUNCTION BOX WILL BE PROVIDED WITH MULTI-PIN CONNECTOR AND CORD IN LIGHTS AS REQUIRED, 25 FT IS STANDARD, OPTIONAL 25 FT INCREMENTS AVAILABLE.
- (5) ALL BURIED PUMP PRESSURE DISCHARGE PIPING SHALL BE PROTECTED WITH TAPECOAT CT CORROSION PROTECTION TAPE.
- 6 OM-300S STAINLESS STEEL FLOAT AND PROBE ASSEMBLY INCLUDES OIL SENSING PROBE, ON FLOAT AND HIGH ALARM FLOAT
- ${ { \mathfrak O} }$ ITEMS 1,3,4,5 AND 6 PROVIDED BY STANCOR AS A STANDARD PACKAGE.

MODEL	H.P.	VOLT.	RATED FLA	DISC. SIZE	MAX. HEAD FT.	MAX. FLOW GPM	WEIGHT LBS.	HEIGHT IN.	WIDTH IN.
SE50	0.50	115	8	2"	37'	74	34	13.2	8.1"

PUMP INFORMATION TYPE: ⊠ SUMP PUMPS(s)


GRINDER PUMPS(s) NON-CLOG PUMP(s)

304 STAINLESS STEEL SCH40 GALVANIZED STEEL SCH80 PVC PIPE

MODEL NO: SE50 RATING: 74 GPM 37' TDH MOTOR: 0.50 HP, 3600 RPM ELEC.: 1PH, 60HZ, 115V ELEC.: 8 FL AMPS

□ 1" ⊠ 2"

ELEVATOR SUMP PUMP DETAIL

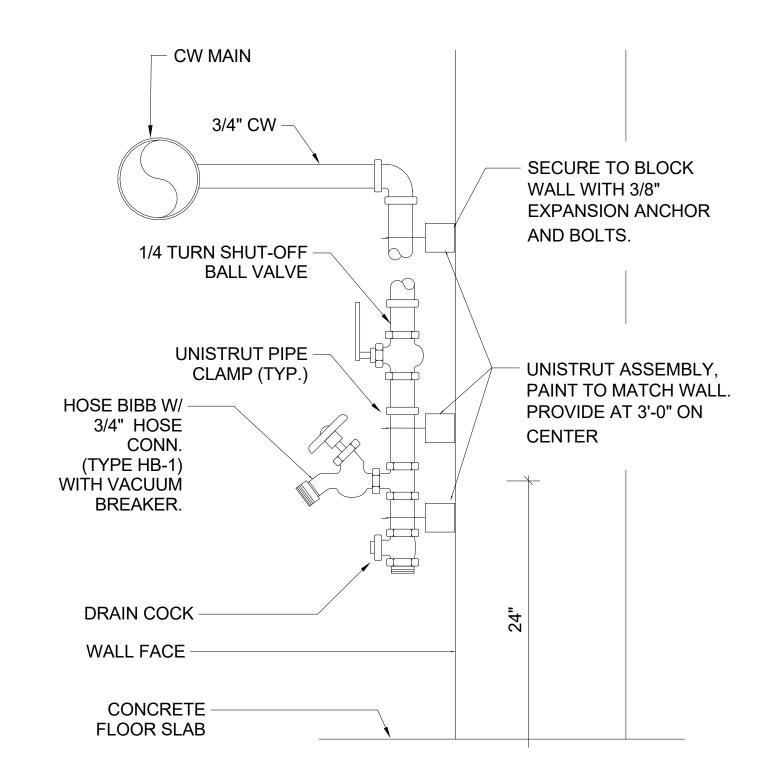





ORPORATE CERTIFICATE OF AUTHORIZATION NUMBER: 5057 www.avconinc.com






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FBPR CA NO. 24

SCHENKELSHULTZ

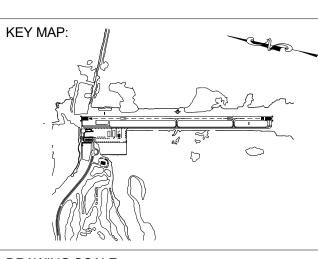

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DESCRIPTION

PROJECT NAME: **NEW TERMINAL FACILITY** AND ASSOCIATED **IMPROVEMENTS**

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VOLUME 2 **ENGINEER OF RECORD:** ZEMP B. PEPPER, PE 41147

1620729 JOB NO. DATE: DRAWN: DESIGN: CHECKED:

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